


# RUSSELL GRONSKY RESIDENCE

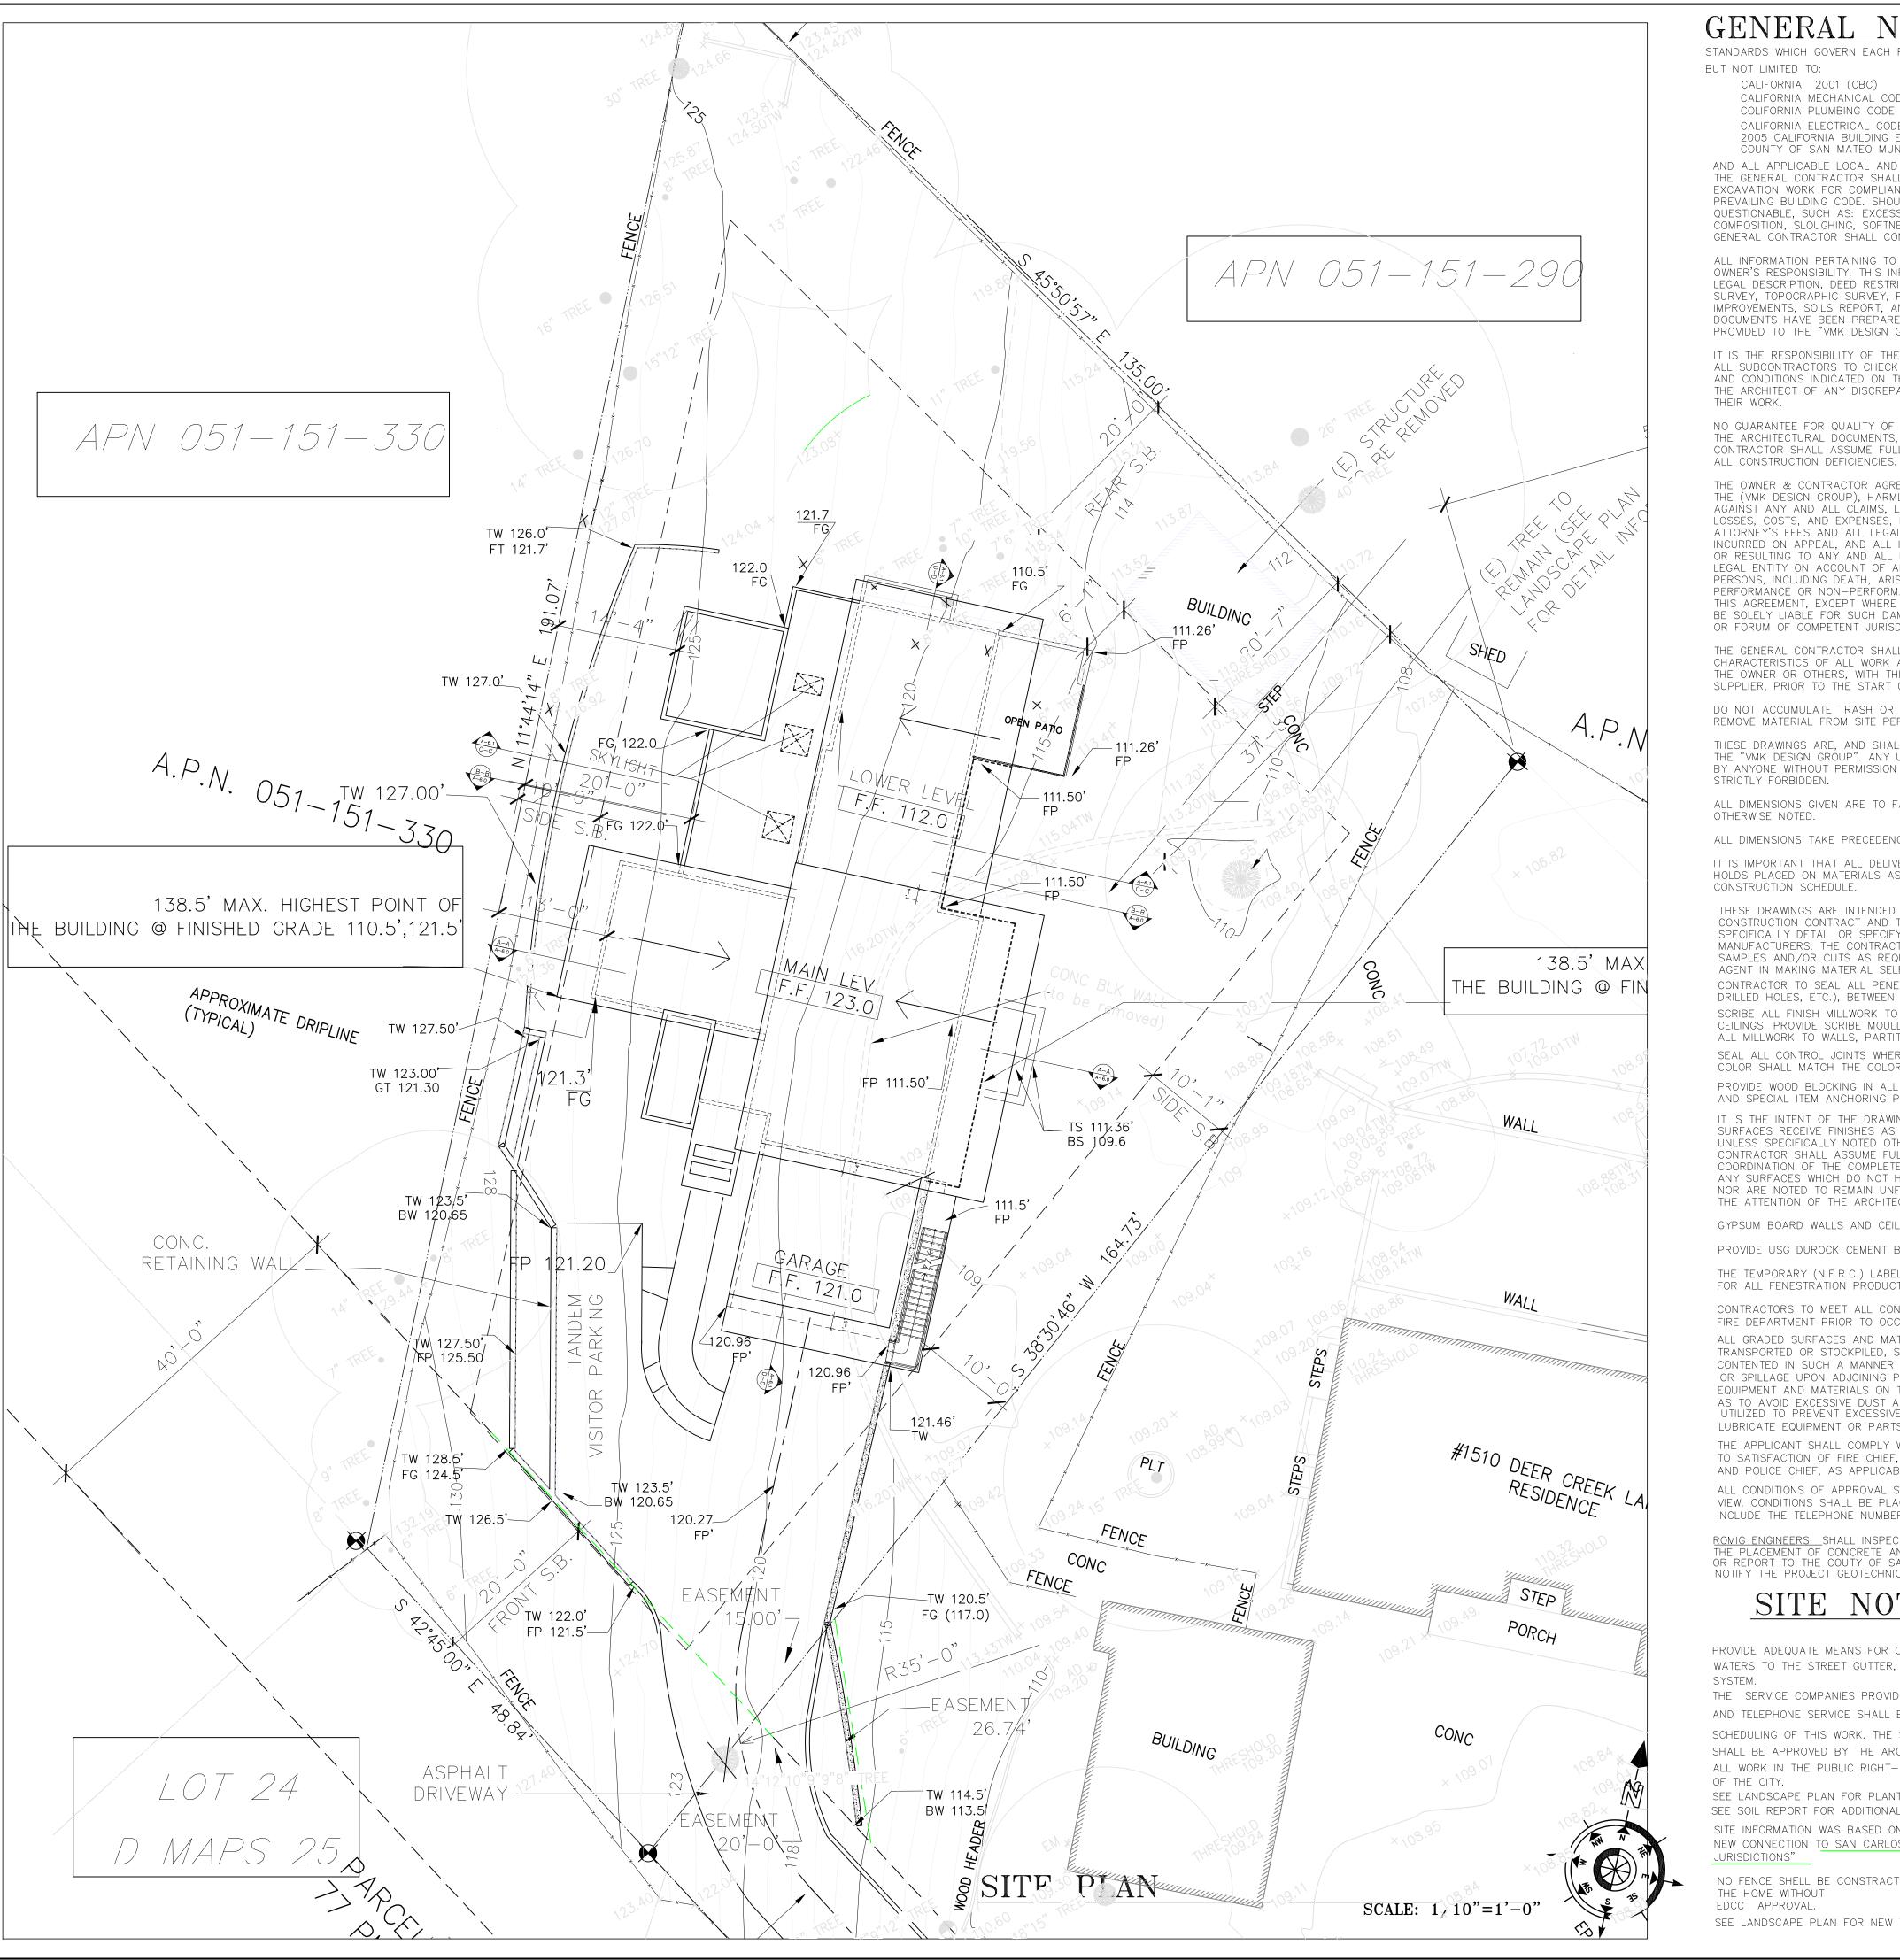





### GENERAL NOTES

STANDARDS WHICH GOVERN EACH PHASE OF WORK, INCLUDING,

BUT NOT LIMITED TO:

CALIFORNIA 2001 (CBC) CALIFORNIA MECHANICAL CODE 2001 EDITION (2000 UMC), COLIFORNIA PLUMBING CODE 2001 (2000 NPC) CALIFORNIA ELECTRICAL CODE 2004 EDITION (2002 NEC), 2005 CALIFORNIA BUILDING ENERGY EFFICIENCY STANDARDS

COUNTY OF SAN MATEO MUNICIPAL CODE AND ALL APPLICABLE LOCAL AND STATE LAWS AND REGULATIONS. THE GENERAL CONTRACTOR SHALL CAREFULLY INSPECT ALL EXCAVATION WORK FOR COMPLIANCE TO REQUIREMENTS OF THE PREVAILING BUILDING CODE. SHOULD ANY CONDITIONS APPEAR QUESTIONABLE, SUCH AS: EXCESSIVE DAMPNESS, GRANULAR COMPOSITION, SLOUGHING, SOFTNESS OR OTHER DEFECTS, THE GENERAL CONTRACTOR SHALL CONTACT THE "VMK DESIGN DROUP".

ALL INFORMATION PERTAINING TO THE SITE SHALL BE THE OWNER'S RESPONSIBILITY. THIS INFORMATION SHALL INCLUDE: LEGAL DESCRIPTION, DEED RESTRICTIONS, EASEMENTS, SITE SURVEY, TOPOGRAPHIC SURVEY, POSITION OF EXISTING IMPROVEMENTS, SOILS REPORT, AND ALL RELATED DATA. THESE DOCUMENTS HAVE BEEN PREPARED ON THE INFORMATION PROVIDED TO THE "VMK DESIGN GROUP".

IT IS THE RESPONSIBILITY OF THE GENERAL CONTRACTOR AND ALL SUBCONTRACTORS TO CHECK AND VERIFY ALL DIMENSIONS AND CONDITIONS INDICATED ON THESE DRAWINGS AND NOTIFY THE ARCHITECT OF ANY DISCREPANCIES PRIOR TO COMMENCING

NO GUARANTEE FOR QUALITY OF CONSTRUCTION IS IMPLIED BY THE ARCHITECTURAL DOCUMENTS, AND THE GENERAL CONTRACTOR SHALL ASSUME FULL RESPONSIBILITY FOR ANY OR

THE OWNER & CONTRACTOR AGREES TO INDEMNIFY, DEFEND, & HOLD THE (VMK DESIGN GROUP), HARMLESS FROM AND AGAINST ANY AND ALL CLAIMS, LIABILITIES, SUITS, DEMANDS, LOSSES, COSTS, AND EXPENSES, INCLUDING REASONABLE ATTORNEY'S FEES AND ALL LEGAL EXPENSES AND FEES INCURRED ON APPEAL, AND ALL INTEREST THEREON, ACCRUING OR RESULTING TO ANY AND ALL PERSONS, FIRMS, OR ANY OTHER LEGAL ENTITY ON ACCOUNT OF ANY DAMAGE TO PROPERTY OR PERSONS, INCLUDING DEATH, ARISING OUT OF THE PERFORMANCE OR NON-PERFORMANCE OF OBLIGATIONS UNDER THIS AGREEMENT. EXCEPT WHERE THE ARCHITECT IS FOUND TO BE SOLELY LIABLE FOR SUCH DAMAGES OR LOSSES BY A COURT OR FORUM OF COMPETENT JURISDICTION.

THE GENERAL CONTRACTOR SHALL VERIFY SIZE, LOCATION, AND CHARACTERISTICS OF ALL WORK AND EQUIPMENT SUPPLIED BY THE OWNER OR OTHERS, WITH THE MANUFACTURER OR SUPPLIER, PRIOR TO THE START OF RELATED WORK.

DO NOT ACCUMULATE TRASH OR DEBRIS ON SITE. PROMPTLY REMOVE MATERIAL FROM SITE PER LOCAL ORDINANCE.

THESE DRAWINGS ARE, AND SHALL REMAIN, THE PROPERTY OF THE "VMK DESIGN GROUP". ANY USE OR REPRODUCTION IN WHOLE OR PART BY ANYONE WITHOUT PERMISSION OF THE ARCHITECT, SHALL BE STRICTLY FORBIDDEN.

ALL DIMENSIONS GIVEN ARE TO FACE OF STUD UNLESS OTHERWISE NOTED.

ALL DIMENSIONS TAKE PRECEDENCE OVER SCALE.

IT IS IMPORTANT THAT ALL DELIVERY TIME BE CHECKED AND HOLDS PLACED ON MATERIALS AS REQUIRED TO MEET CONSTRUCTION SCHEDULE.

THESE DRAWINGS ARE INTENDED FOR USE IN A NEGOTIATED CONSTRUCTION CONTRACT AND THEREFORE, MAY NOT SPECIFICALLY DETAIL OR SPECIFY MATERIALS AND/OR MANUFACTURERS. THE CONTRACTOR SHALL PROVIDE ALL SAMPLES AND/OR CUTS AS REQUIRED TO ASSIST OWNER OR HIS AGENT IN MAKING MATERIAL SELECTIONS.

CONTRACTOR TO SEAL ALL PENETRATIONS, (E.G. FROM PIPES, DRILLED HOLES, ETC.), BETWEEN FLOORS AND WALLS. SCRIBE ALL FINISH MILLWORK TO WALLS, PARTITIONS, AND ALL MILLWORK TO WALLS, PARTITIONS, AND CEILINGS.

SEAL ALL CONTROL JOINTS WHERE EXPOSED TO VIEW. SEALANT COLOR SHALL MATCH THE COLOR OF THE FINISH MATERIAL. PROVIDE WOOD BLOCKING IN ALL STUD WALLS AT MILLWORK AND SPECIAL ITEM ANCHORING POINTS.

IT IS THE INTENT OF THE DRAWINGS THAT ALL EXPOSED SURFACES RECEIVE FINISHES AS INDICATED ON THE DRAWINGS UNLESS SPECIFICALLY NOTED OTHERWISE. THE GENERAL CONTRACTOR SHALL ASSUME FULL RESPONSIBILITY FOR THE COORDINATION OF THE COMPLETE FINISH-OUT OF THE PROJECT ANY SURFACES WHICH DO NOT HAVE A SPECIFIC FINISH NOTED, NOR ARE NOTED TO REMAIN UNFINISHED, SHALL BE BROUGHT TO THE ATTENTION OF THE ARCHITECT AND FINISHED PER THE

GYPSUM BOARD WALLS AND CEILINGS SHALL HAVE A SMOOTH

PROVIDE USG DUROCK CEMENT BOARD AT ALL AREAS SUBJECT

THE TEMPORARY (N.F.R.C.) LABEL WHICH STATES THE LISTED U-VALUE FOR ALL FENESTRATION PRODUCTS SHALL NOT BE REMOVED PRIOR

CONTRACTORS TO MEET ALL CONDITIONS OF BUILDING AND FIRE DEPARTMENT PRIOR TO OCCUPANCY

ALL GRADED SURFACES AND MATERIALS, WHETHER FILED, EXCAVATED, TRANSPORTED OR STOCKPILED, SHALL BE WETTED, PROTECTED OR CONTENTED IN SUCH A MANNER AS TO PREVENT ANY NUISANCE FROM DUST, OR SPILLAGE UPON ADJOINING PROPERTY OR STREETS. EQUIPMENT AND MATERIALS ON THE SITE SHOULD BE USED IN SUCH A MANNER AS TO AVOID EXCESSIVE DUST AND NOISE. ROADWAYS ON THE SITE SHALL BE UTILIZED TO PREVENT EXCESSIVE DUST. DIESEL OIL SHALL NOT BE UTILIZED TO

LUBRICATE EQUIPMENT OR PARTS ON SITE. THE APPLICANT SHALL COMPLY WITH ALL CONDITIONS SPECIFIED IN ORDINANCE #1056, TO SATISFACTION OF FIRE CHIEF, PUBLIC WORKS DIRECTOR, CHIEF BUILDING OFFICIAL AND POLICE CHIEF, AS APPLICABLE

ALL CONDITIONS OF APPROVAL SHALL BE POSTED AT THE JOB SITE IN FULL PUBLIC VIEW. CONDITIONS SHALL BE PLACED IN A WEATHERPROOF COVER, AND SHOULD INCLUDE THE TELEPHONE NUMBER OF THE DEVELOPER.

ROMIG ENGINEERS SHALL INSPECT ALL EXCAVATIONS AND GRADING PRIOR TO THE PLACEMENT OF CONCRETE AND / OR BACKFILL AND SUBMIT AN "AS-BUILT" LETTER OR REPORT TO THE COUTY OF SAN MATEO. IT IS RESPONSIBILITY OF THE CONTRACTOR TO NOTIFY THE PROJECT GEOTECHNICAL CONSULTANT TO THE REQUIRED INSPECTIONS.

### SITE NOTES


PROVIDE ADEQUATE MEANS FOR COLLECTING AND DIRECTING SUB-SURFACE WATERS TO THE STREET GUTTER, STORM DRAIN, OR OTHER APPROVED DRAIN

THE SERVICE COMPANIES PROVIDING NATURAL GAS, ELECTRICITY, WATER, CABLE, AND TELEPHONE SERVICE SHALL BE CONSULTED ON THE LOCATION AND THE SCHEDULING OF THIS WORK. THE SERVICE ENTRANCE AND THE METER LOCATION SHALL BE APPROVED BY THE ARCHITECT PRIOR TO THEIR INSTALLATION. ALL WORK IN THE PUBLIC RIGHT-OF-WAY SHALL CONFORM TO THE STANDARDS

SEE LANDSCAPE PLAN FOR PLANTING & IRRIGATION REQUIREMENTS SEE SOIL REPORT FOR ADDITIONAL REQ. "ROMIG ENGINEERS" SITE INFORMATION WAS BASED ON SURVEY BY TRIED HOME ASSOC. NEW CONNECTION TO SAN CARLOS CITY SEWER SYSTEM "EXTRA TERRITORIAL

NO FENCE SHELL BE CONSTRACTED ALONG THE BELLE ROCHE AVE. SIDE OF THE HOME WITHOUT EDCC APPROVAL.

SEE LANDSCAPE PLAN FOR NEW TREE LOCATION

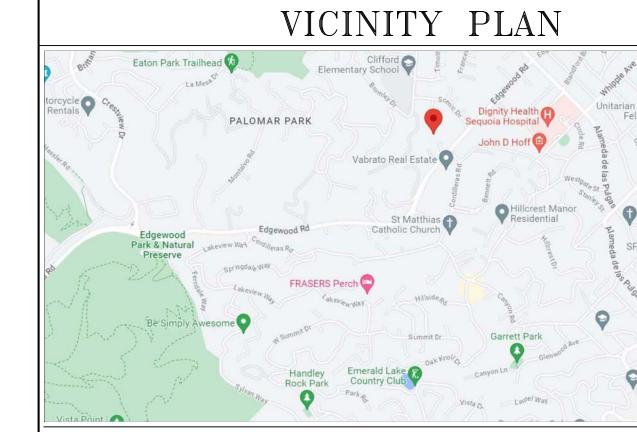

### PROJECT TEAM

ARCHITECT @ STRUCTURE VMK DESIGN GROUP Vadim Melik-Karamov 3777 STEVENS CREEK BLVD. #420 SANTA CLARA CA 95051 PH. (408) 554-6110

CIVIL ENGINEER — LAND SURVEYING

MacLEOD AND ASSOCIATES 965 CENTER STREET \_SAN CARLOS\_CA PHONE (650) 593-8580 SOILS REPORT

ROMIG ENGINEERS 1390 EL CAMINO REAL CA. 94070 PHONE (650) 591-5224

MAYNE TREE EXPERT COMPANY 535 BRAGATO RD, SITE. A SAN CARLOS CA.94070

PHONE (650) 594-4400

### PLANNING DATA

051 - 151 - 260A.P.N. LOT AREA: 15,000 SF (E) ZONING CLASSIFICATION: R-1/3-91/DRPROPORTY ONER: RUSSEL GRONSKIY SINGLE FAMILY PROPOSED USE: OCCUPANCY GROUP: R-3TYPE OF CONSTRUCTION:

V-N (N/SPRINKLERED) SETBACKS: FRONT-REAR-

ALLOWABLE-PROPOSED

PARKING REQUIRED PARKING PROPOSED 2 CARS 4 CARS

COVERAGE 4,500 SQ.FT (30%) ALLOWABLE-2,970 SQ.FT PROPOSED BUILDING F.A.: ALLOWABLE HOUSE-4,100 SQ.FT 400 SQ.FT GARAGE

2,282.0 SQ.FT MAIN LEVEL 1,817.0 SQ.FT LOWER LEVEL 400 SQ.FT 4,099.0 SQ.FT PROPOSED HOUSE

#### DRAWING INDEX ARCHITECTURA

A-0.0 Rendering of proposed residence A-0.1 Site Plan, Compliance Data A-1.0 Lower Level Floor Plan A-2.0 Main Level Floor Plan A-3.0 Proposed Roof Plan A-5.0 Proposed Elevations A-5.1 Proposed Elevations A-5.2 3D Model and Bird View Site A-5.3 Specifications A-6.0 "A-A": "B-B" Section A-6.1 "C-C": "D-D" Section <u>SURVEY</u> S-1.0 Boundary Topographic Survey Plan

AR-1.0 Tree location Plan

C-1 Boundary Topographic Survey Plan

C-2 Preliminary Grading Drainage and Utility Plan C—3 Preliminary Grading Drainage and Utility Plan C-4 Erosion & Sedimentation Controls Plan

C-5 Construction BMP Plan

### DESCRIPTION OF THE WORK

NEW FOUR BEDROOMS SINGLE FAMILY RESIDENCE

 $\square$ RESID  $\Box$ ER DE 

PLANNING

BUILDING

XXXXXX

<u>'</u>ප

 $| \mathbf{v} | \subseteq$ 

P

I⊠

10/31/23 AS SHOWN DRAWN TEST SHEET A - 0.1


 $\overline{\phantom{a}}$ 



RUSSELL GRONSKY RESIDENCE 1508 DEER CREEK LANE. REDWOOD CITY, CA 94062

10/31/23 3/16"=1'-0


A-1.0
SHEETS

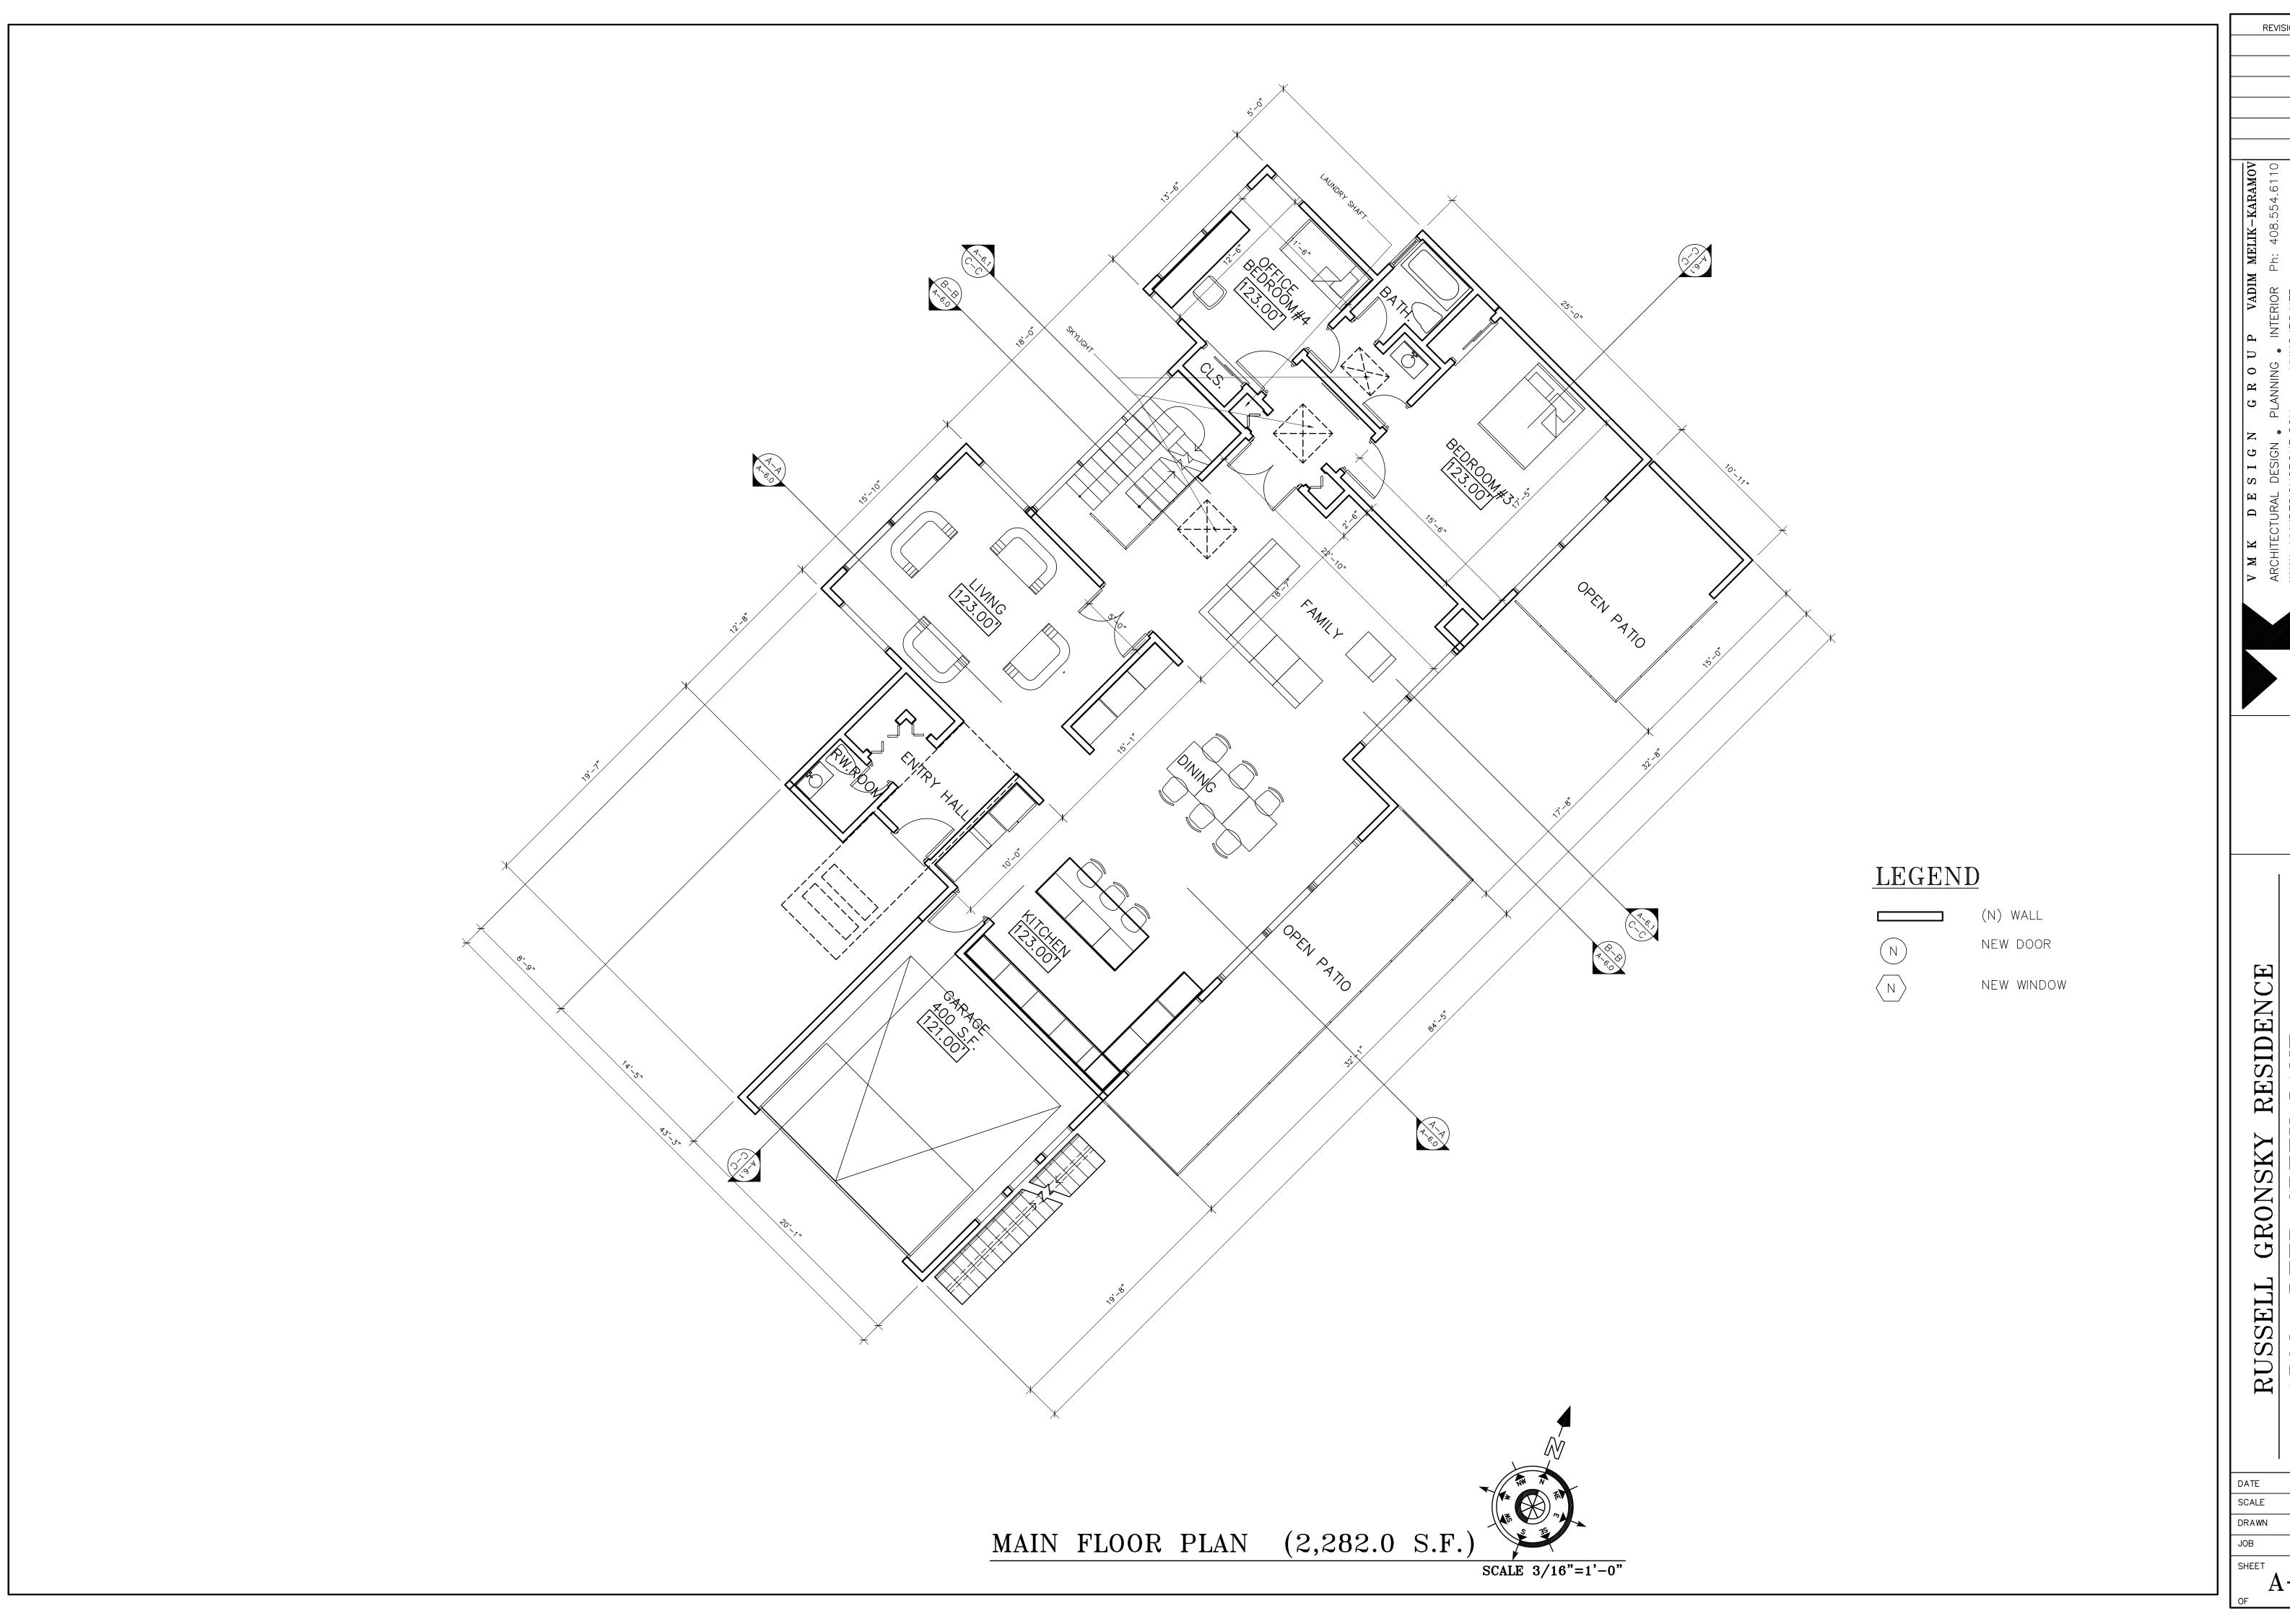

RUSSELL GRONSKY RESIDENCE 1508 DEER CREEK LANE. REDWOOD CITY, CA 94062

3/16"=1'-0

A-2.0
SHEETS

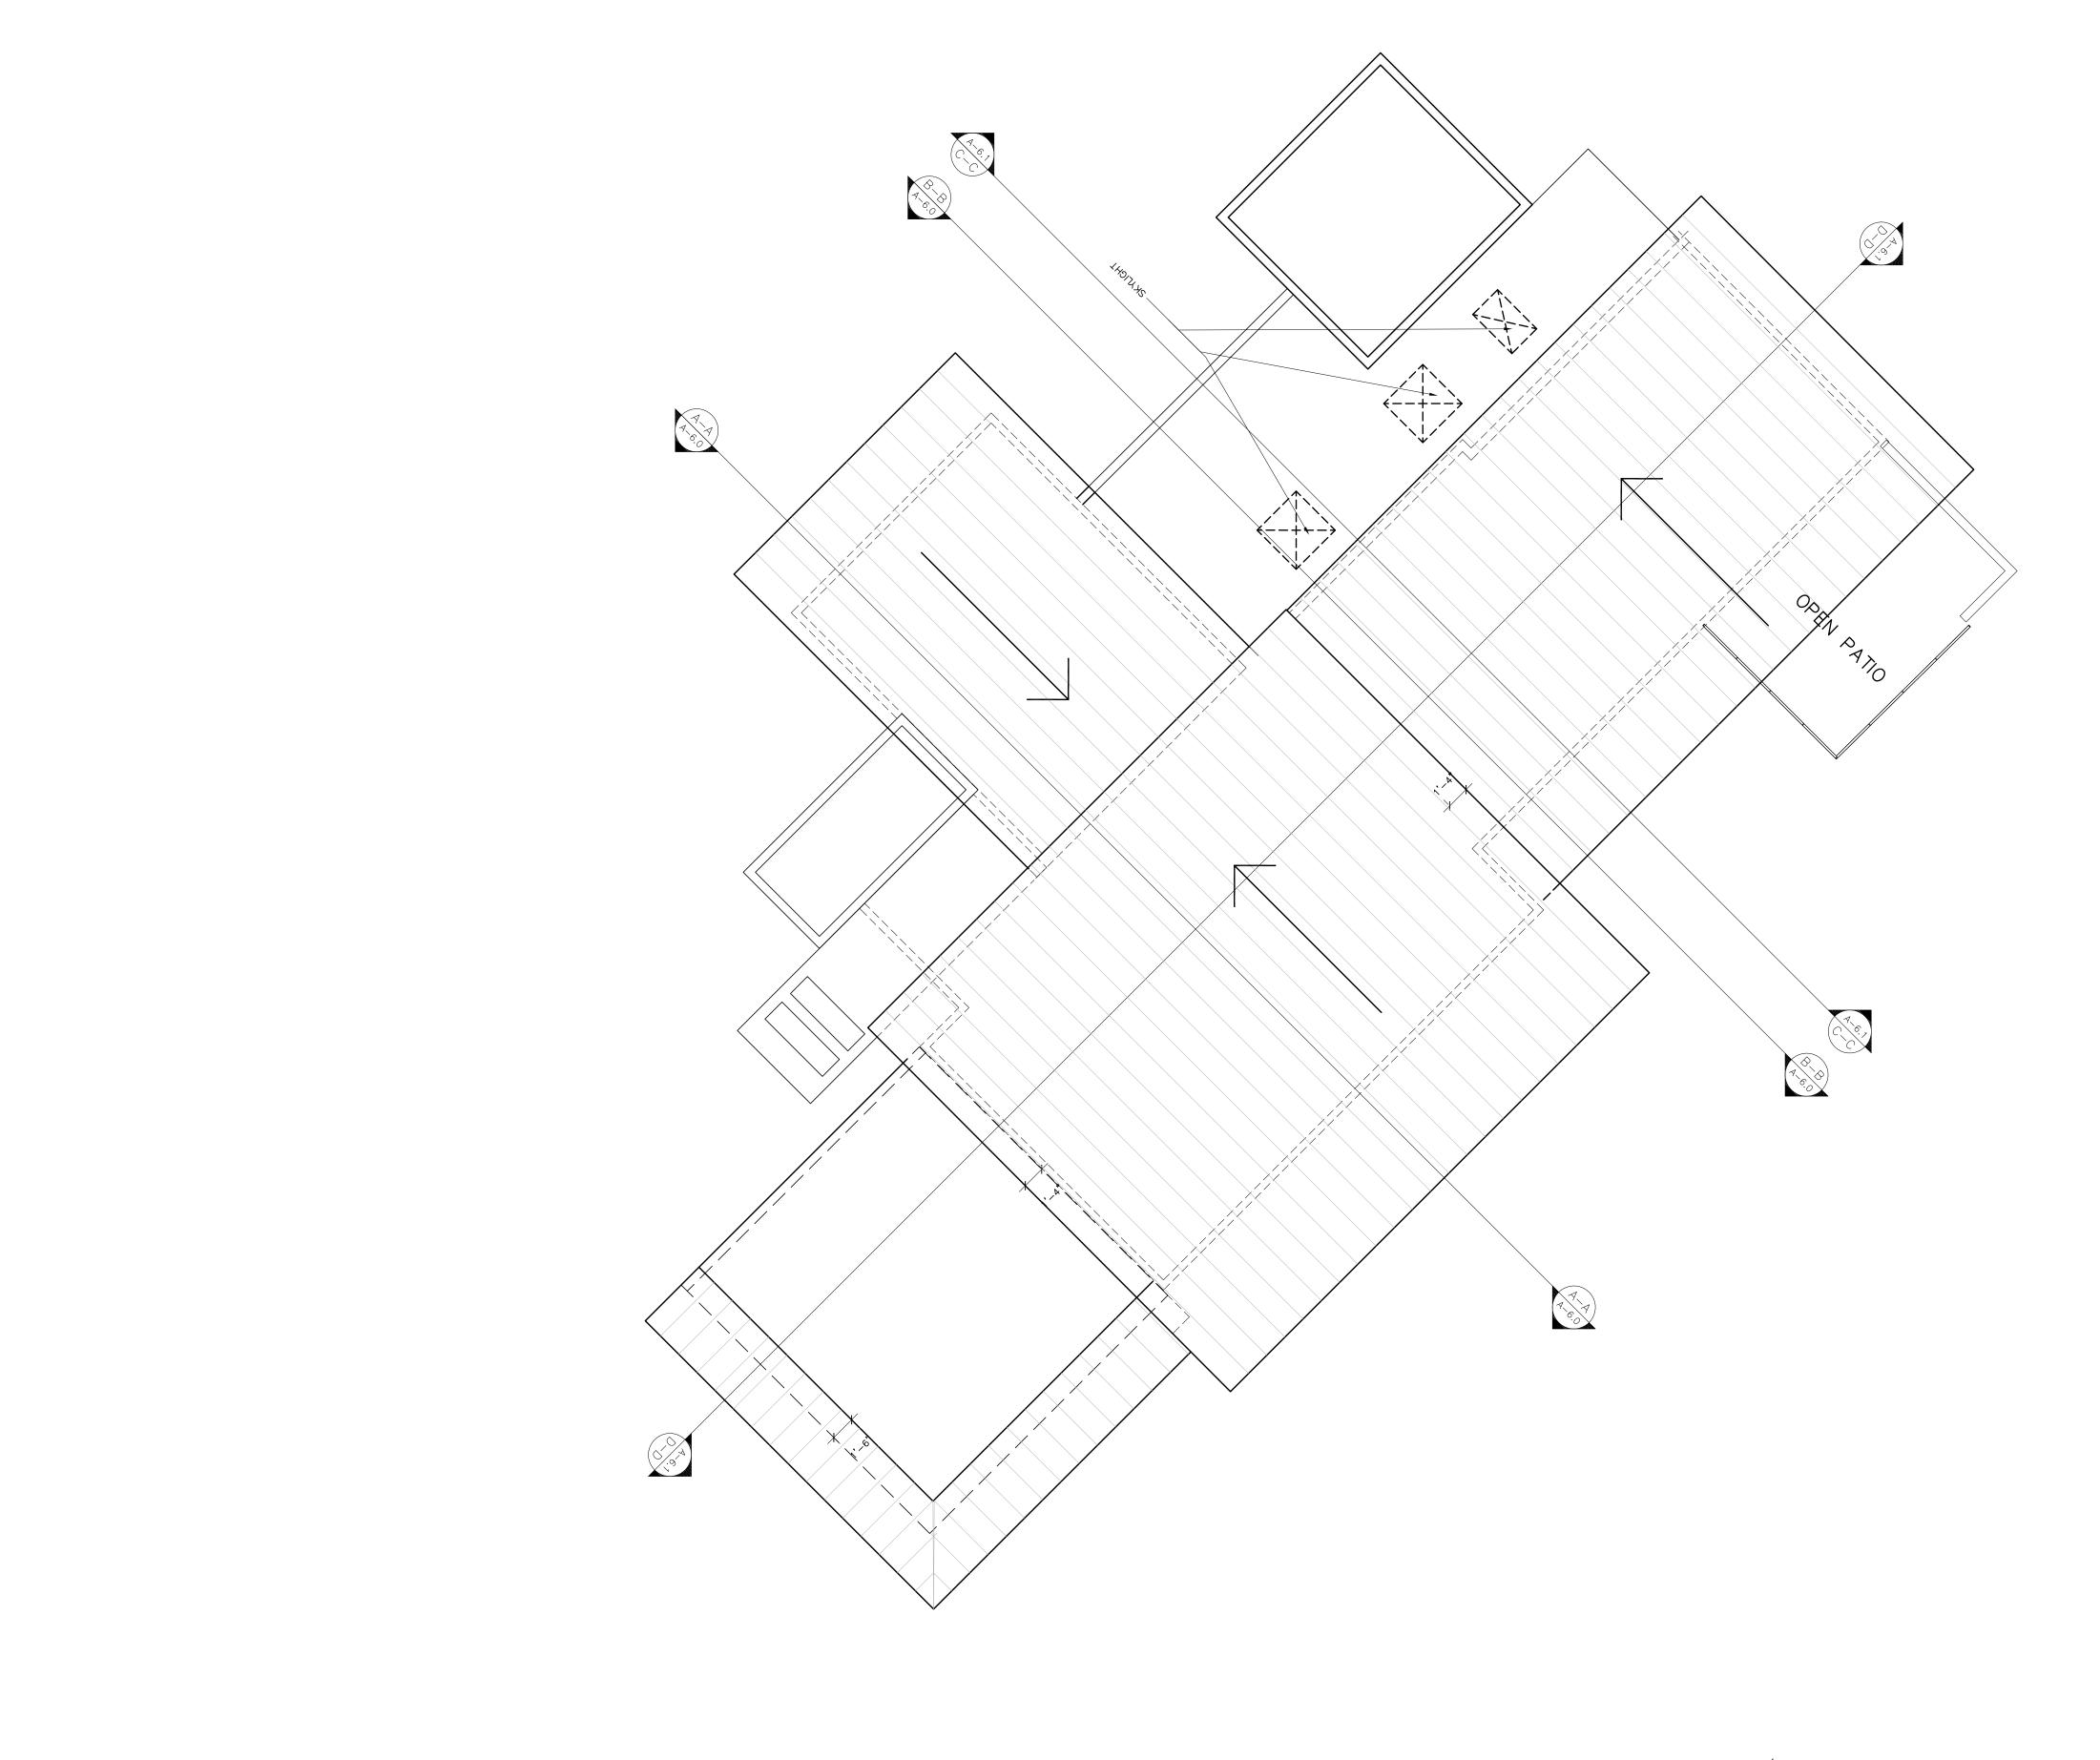

SCALE 3/16"=1'-0"


ROOF PLAN

RUSSELL GRONSKY RESIDENCE 1508 DEER CREEK LANE. REDWOOD CITY, CA 94062


DATE 10/31/23SCALE 3/16"=1"-0"DRAWN VMK

JOB RUSS

SHEET A-3.0OF SHEETS

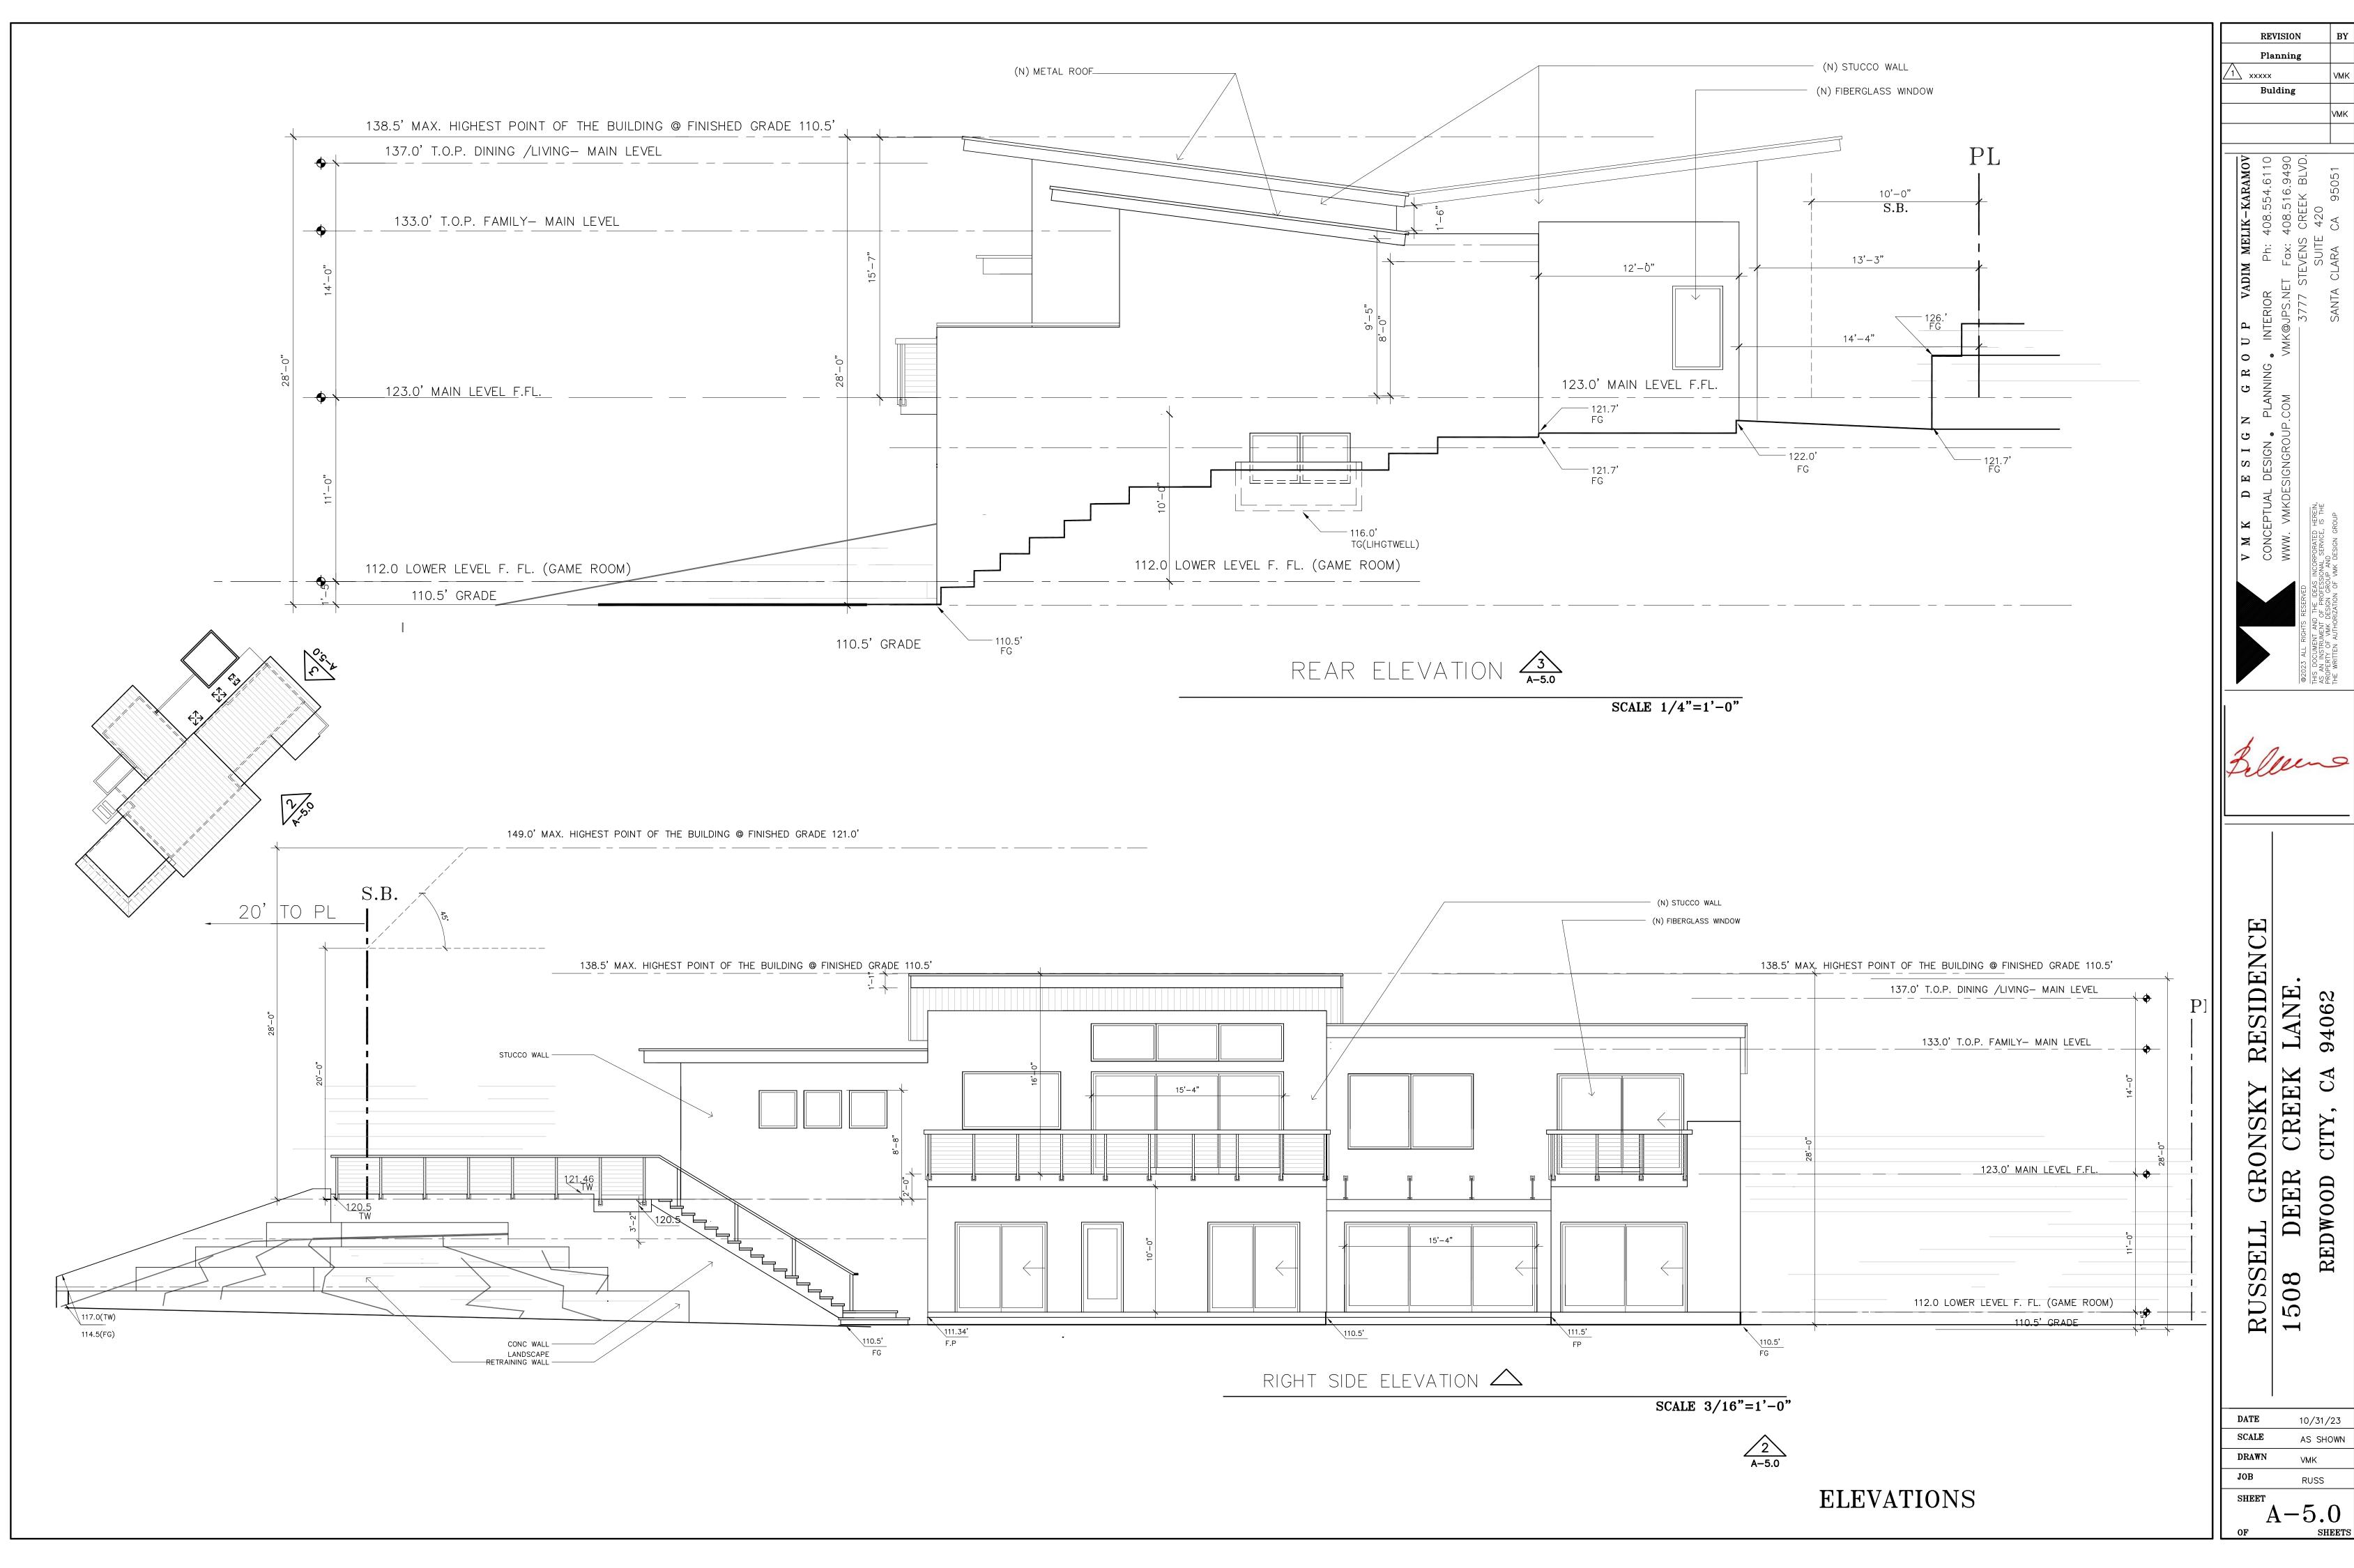


10/31/23

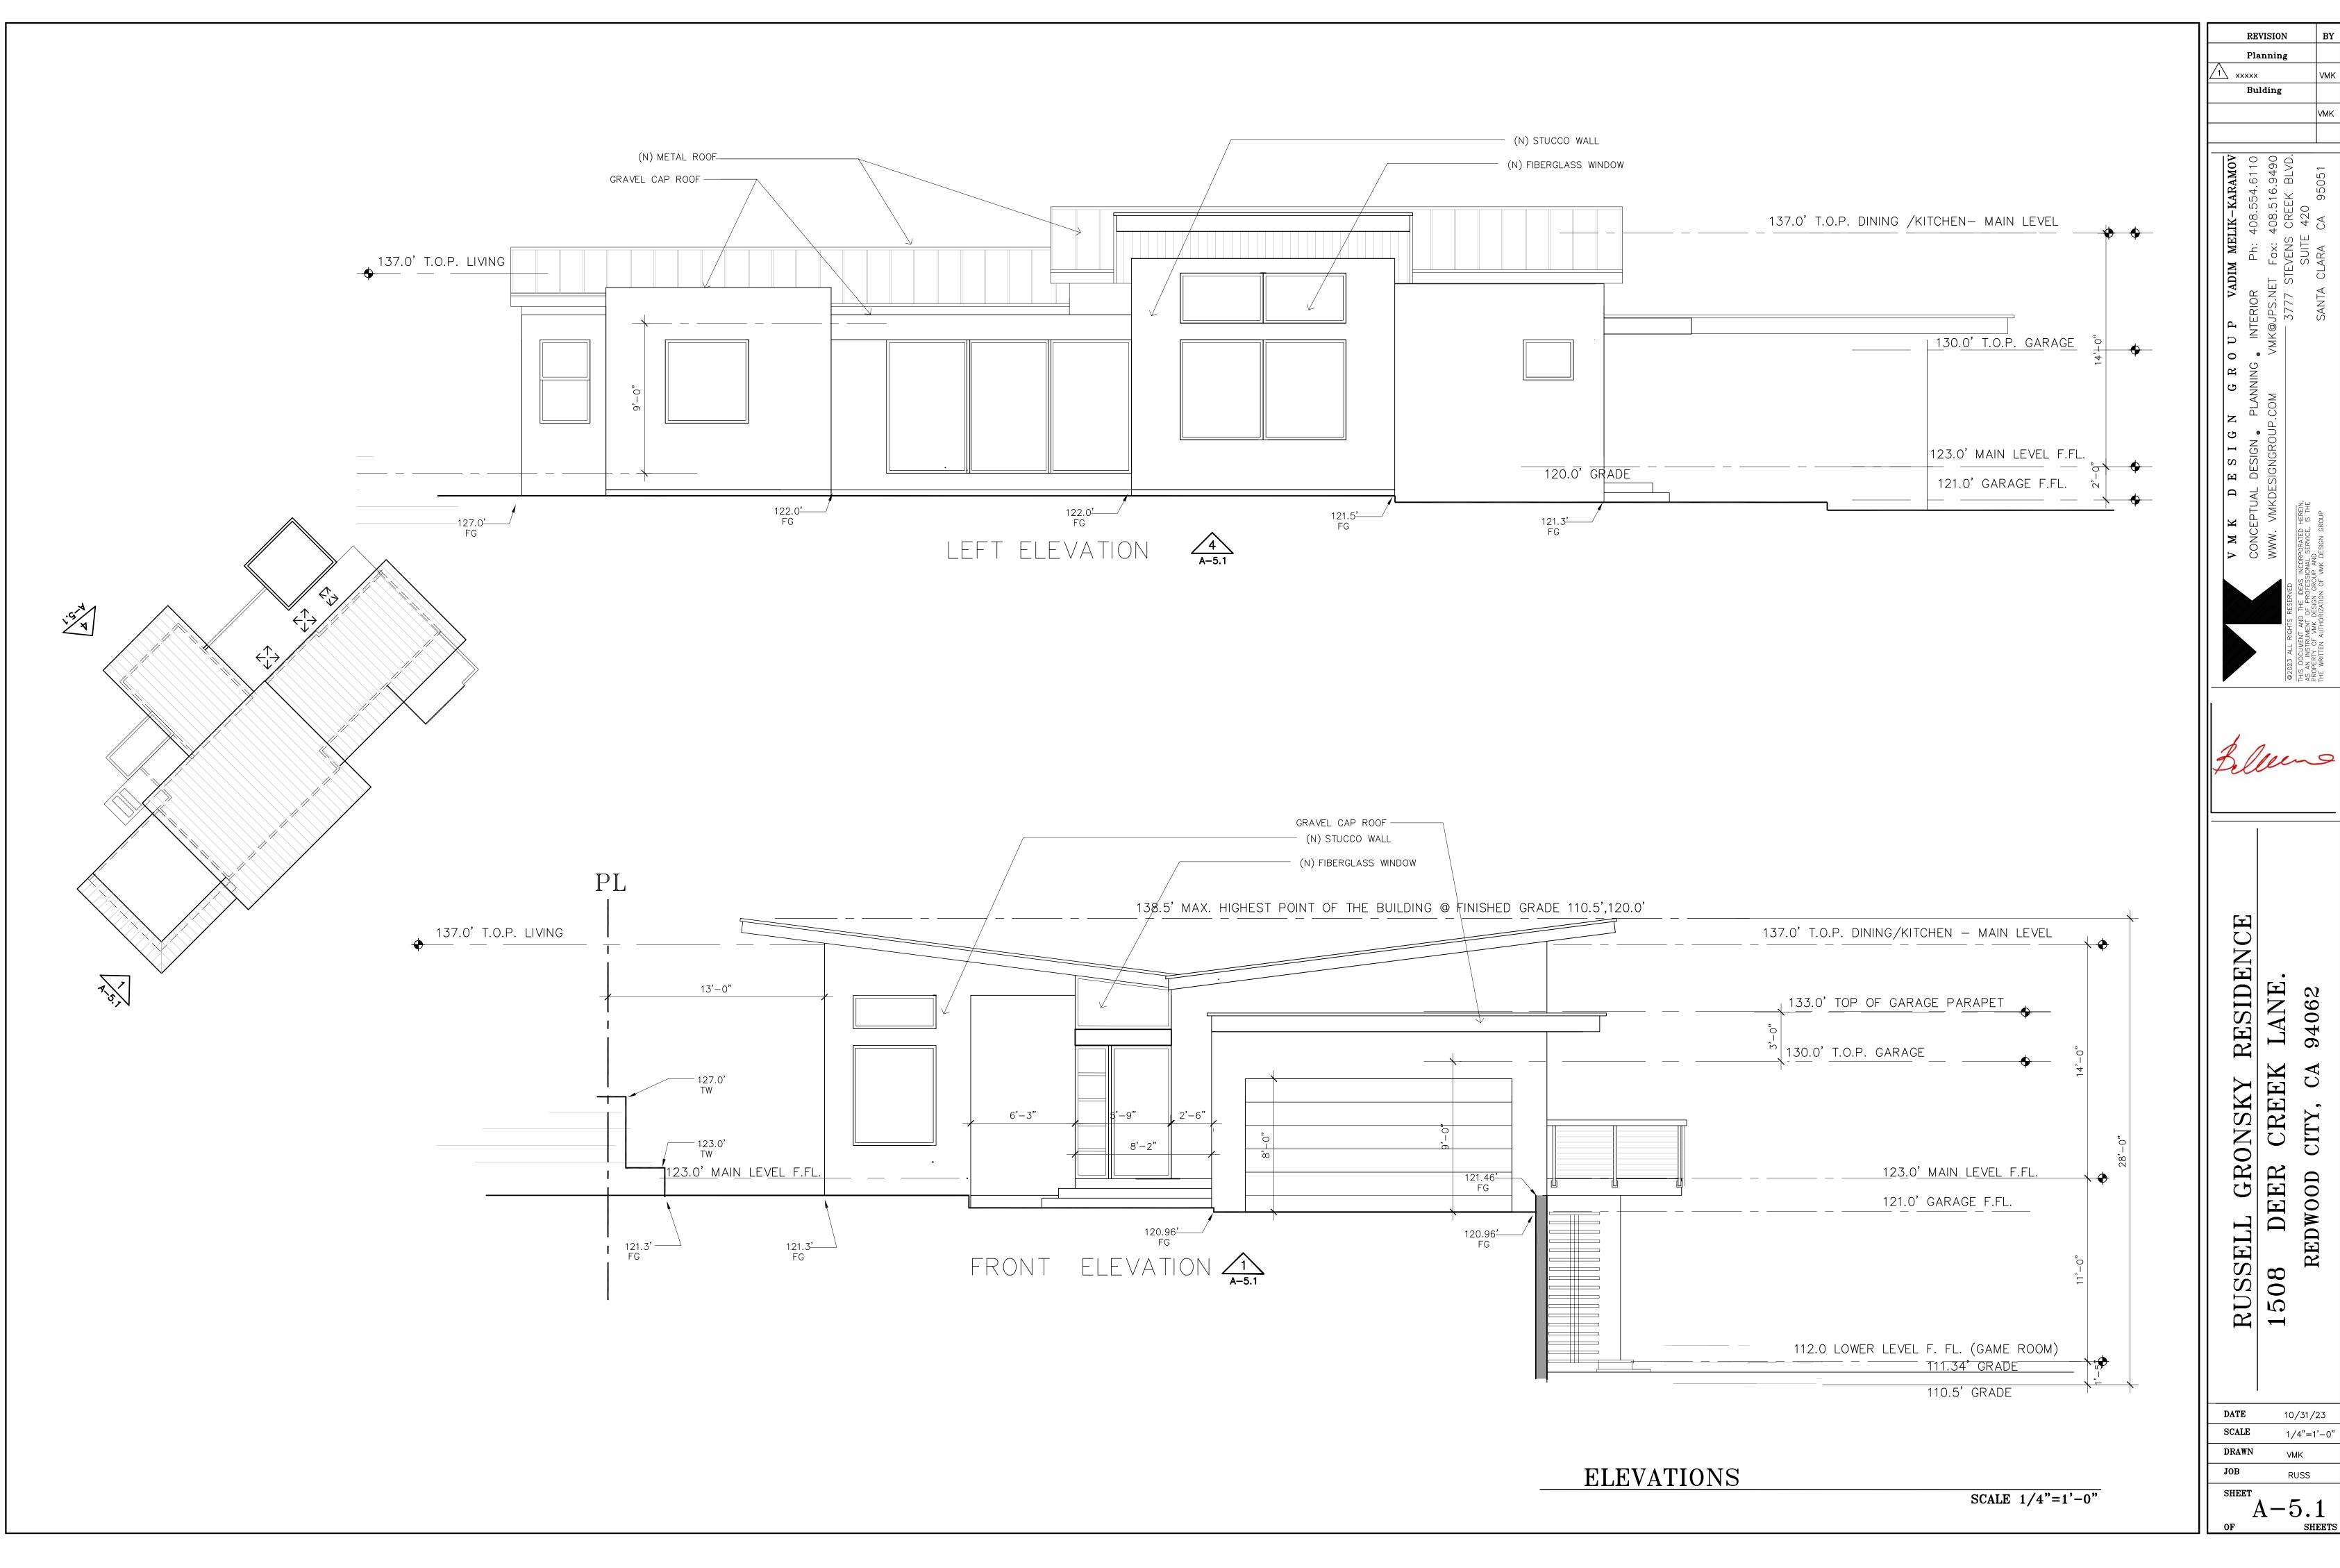


SSELL GRONSKY F 18 DEER CREEK REDWOOD CITY, CA


RUSS	1508
TE	10/31/23
ALE	1/4"=1'-0"
RAWN	VMK


RUSS

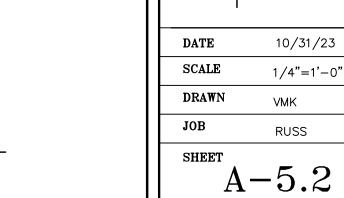

N.T.S.

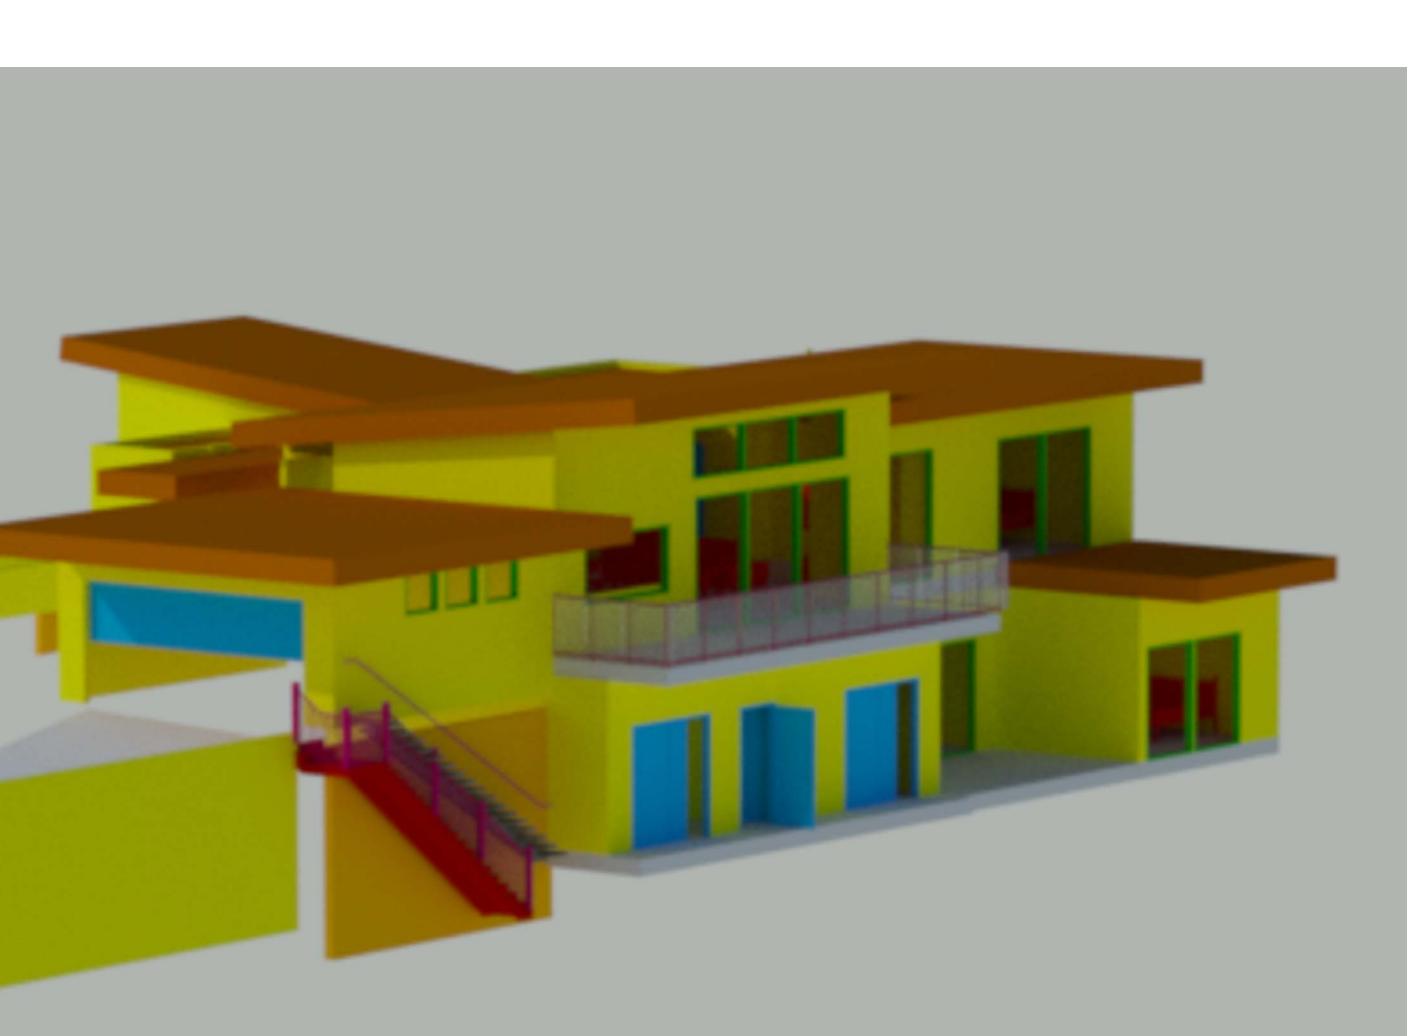

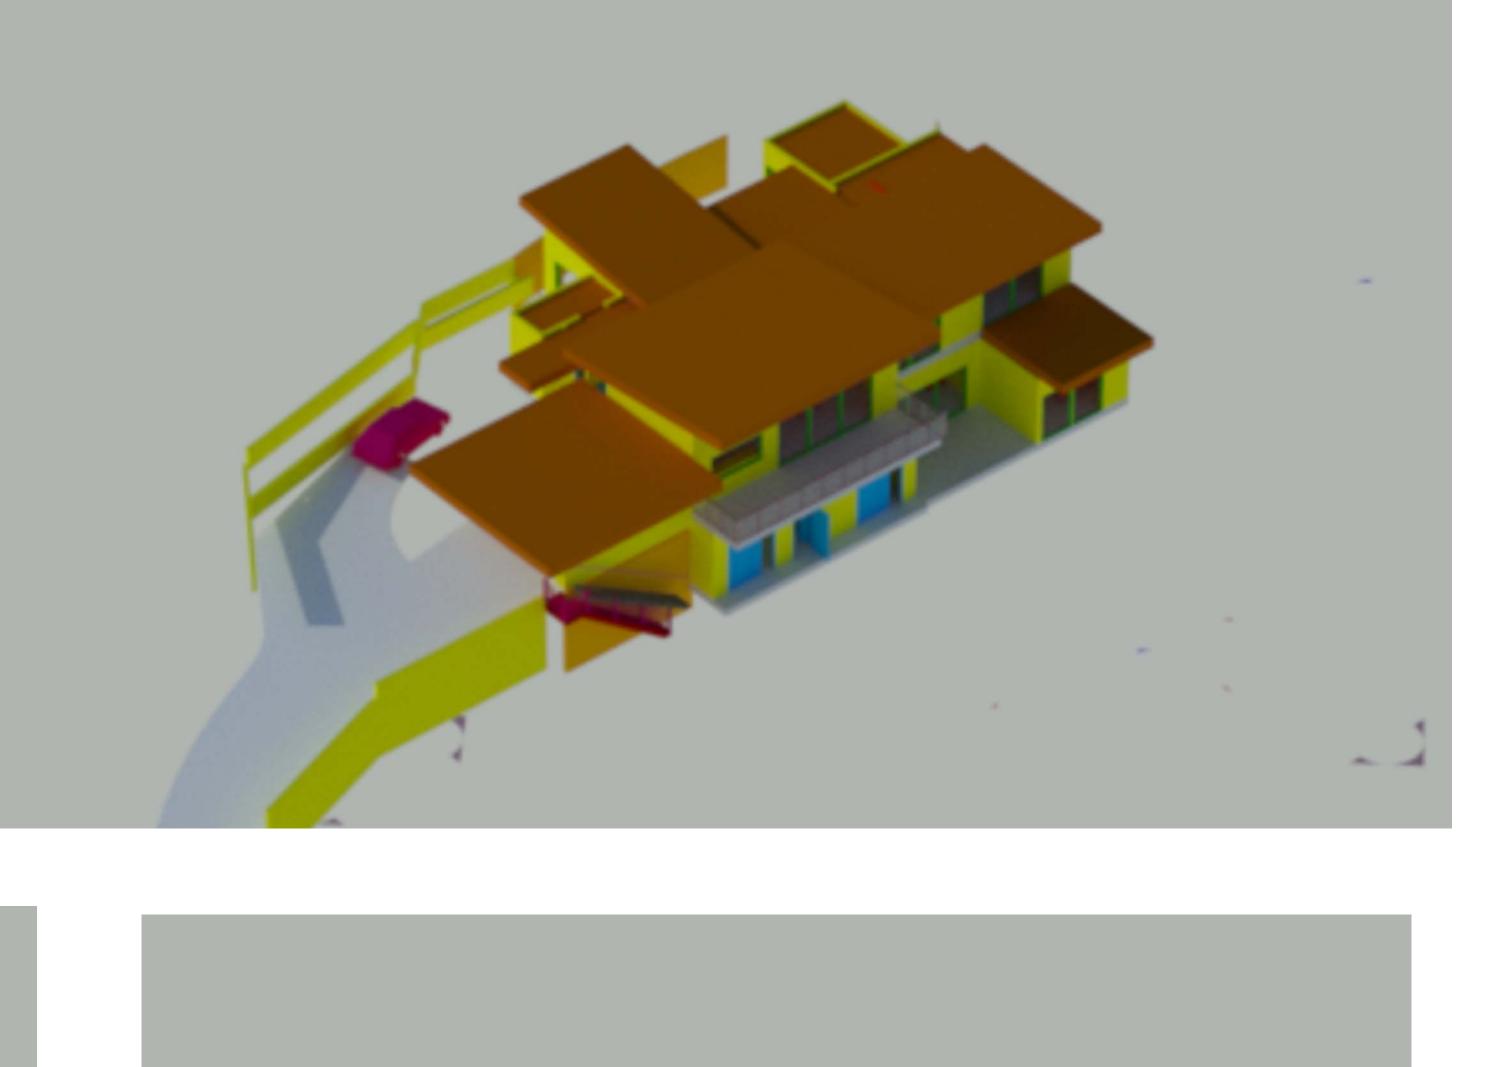

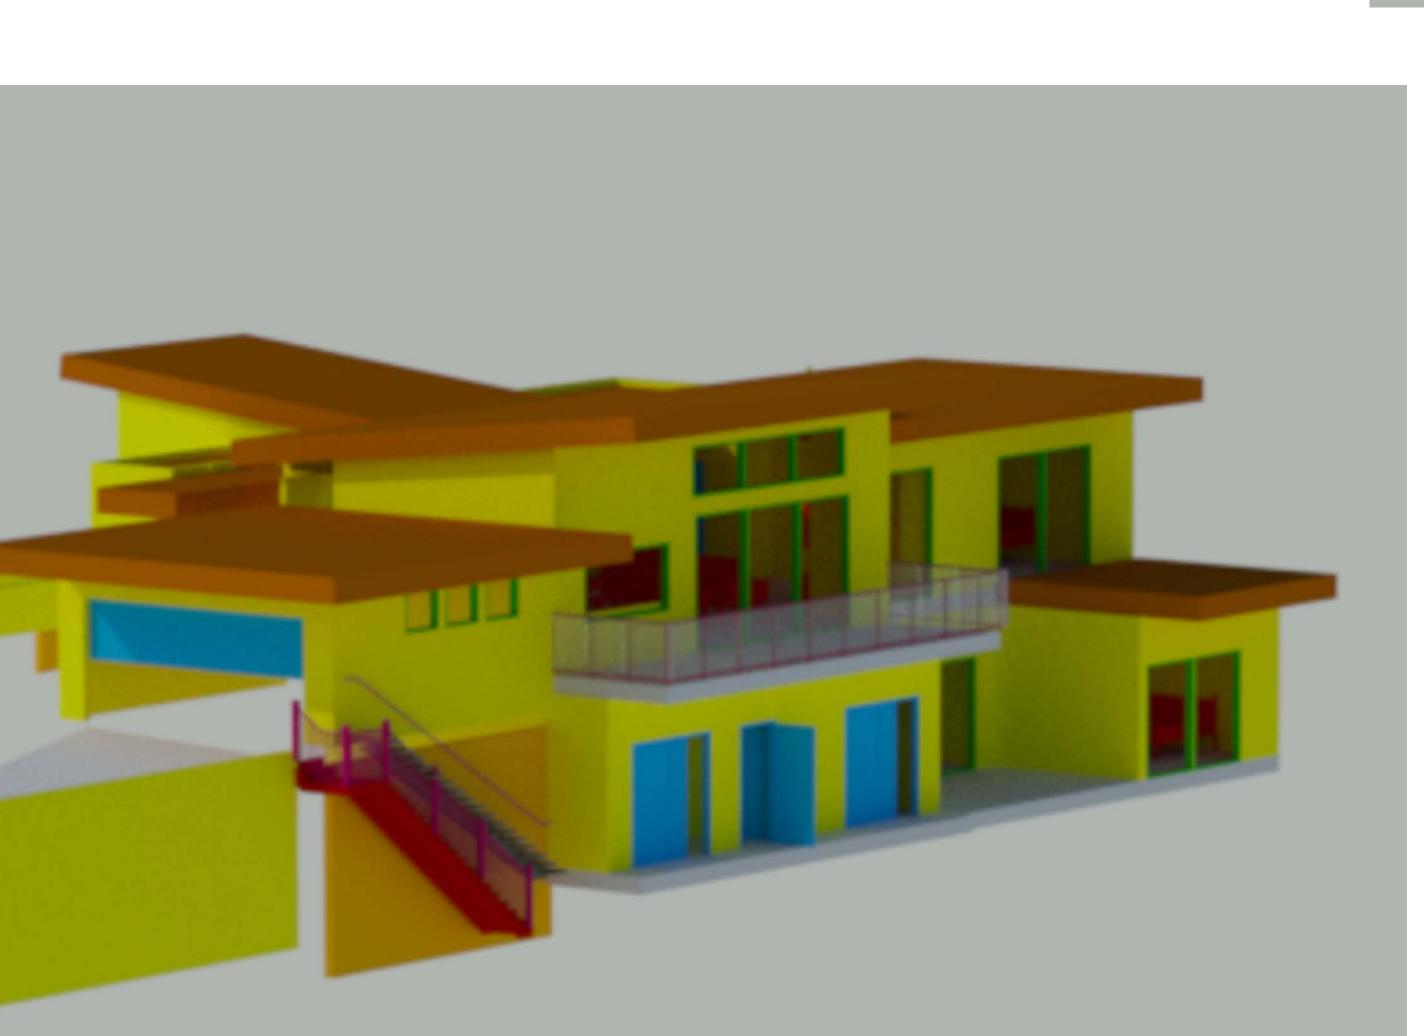




V M K  CONCEPTU  WWW. VMK  ©2022 ALL RIGHTS RESERVED  THIS DOCUMENT AND THE IDEAS INCORPORATED HEREIN	AS AN INSTRUMENT OF PROFESSIONAL SERVICE, IS THE PROPERTY OF VMK DESIGN GROUP AND THE WRITTEN AUTHORIZATION OF VMK DESIGN GROUP
Belleen	9

RESIDENCE
K LANE.
A 94062


RUSSELL GRONSKY R 1508 DEER CREEK REDWOOD CITY, CA 9



AX550 Moving Glass Walls Stacking Door

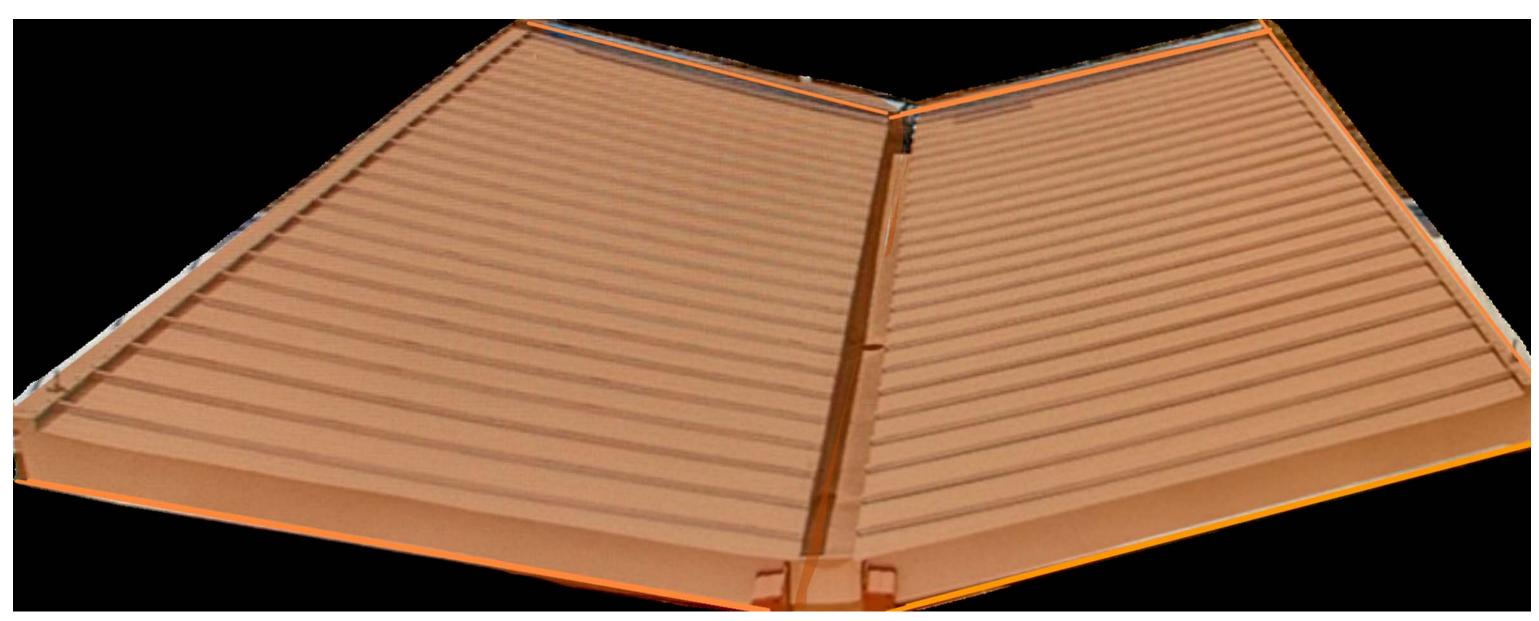

Mechanically Seamed Standing Seam Concealed Fastener Metal Panel

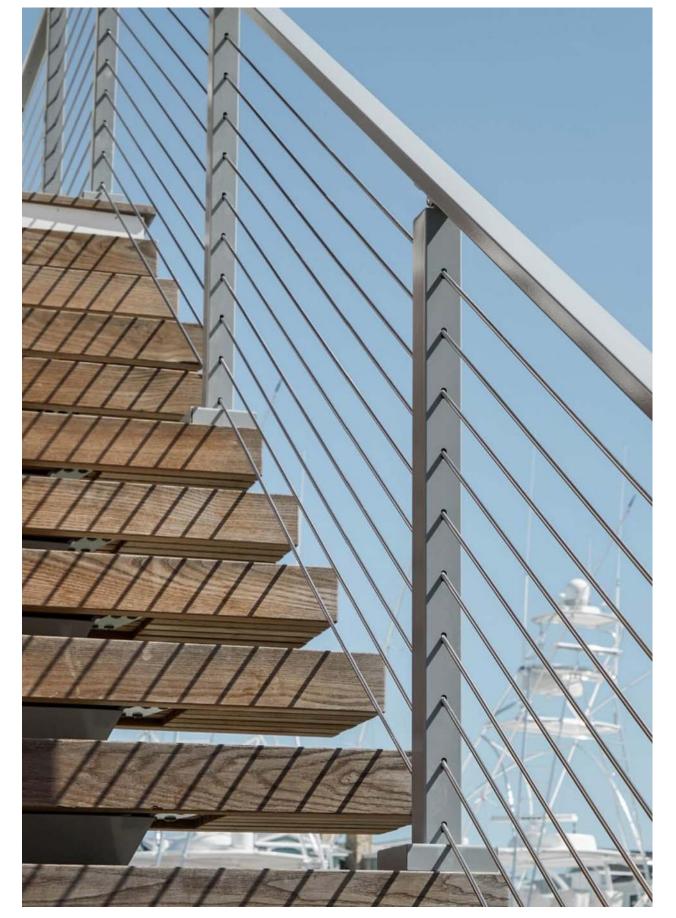


MonoFLIGHT\_Exterior\_ApolloWhite



CableRailing\_AluminumSpeedboatSilver\_ ColonialGrayHandrail



lumenos-20-inch-high-blackled-modern-landscape-pathlight\_\_70t83cropped

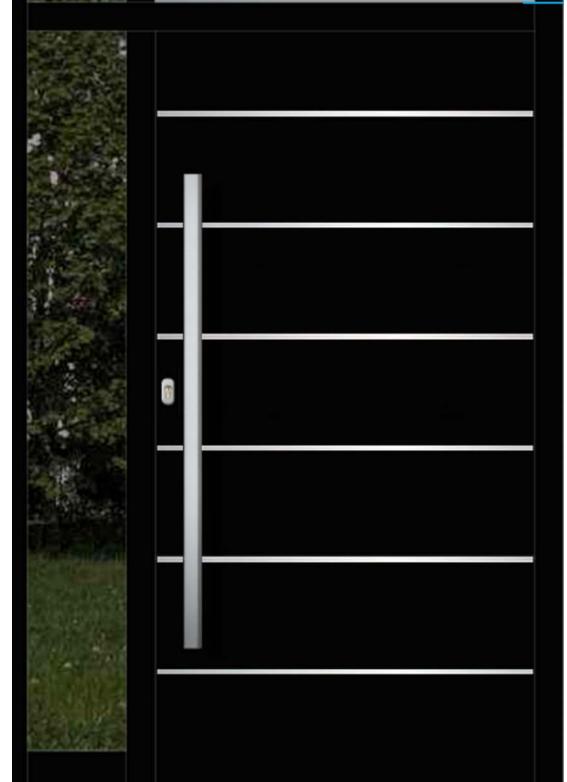

Front Door




Garage Door


SPECIFICATIONS


ıaı	шш			
×		VMK		
ul	ding			
				VMK
00.334.0110	08.516.9490	EK BLVD.	0	95051
000	08	CREEK	420	<b>Y</b>




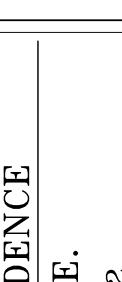


RUSSELL GRONSKY RESIDENCE 1508 DEER CREEK LANE. REDWOOD CITY, CA 94062

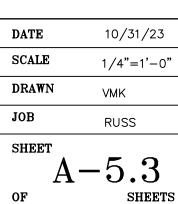

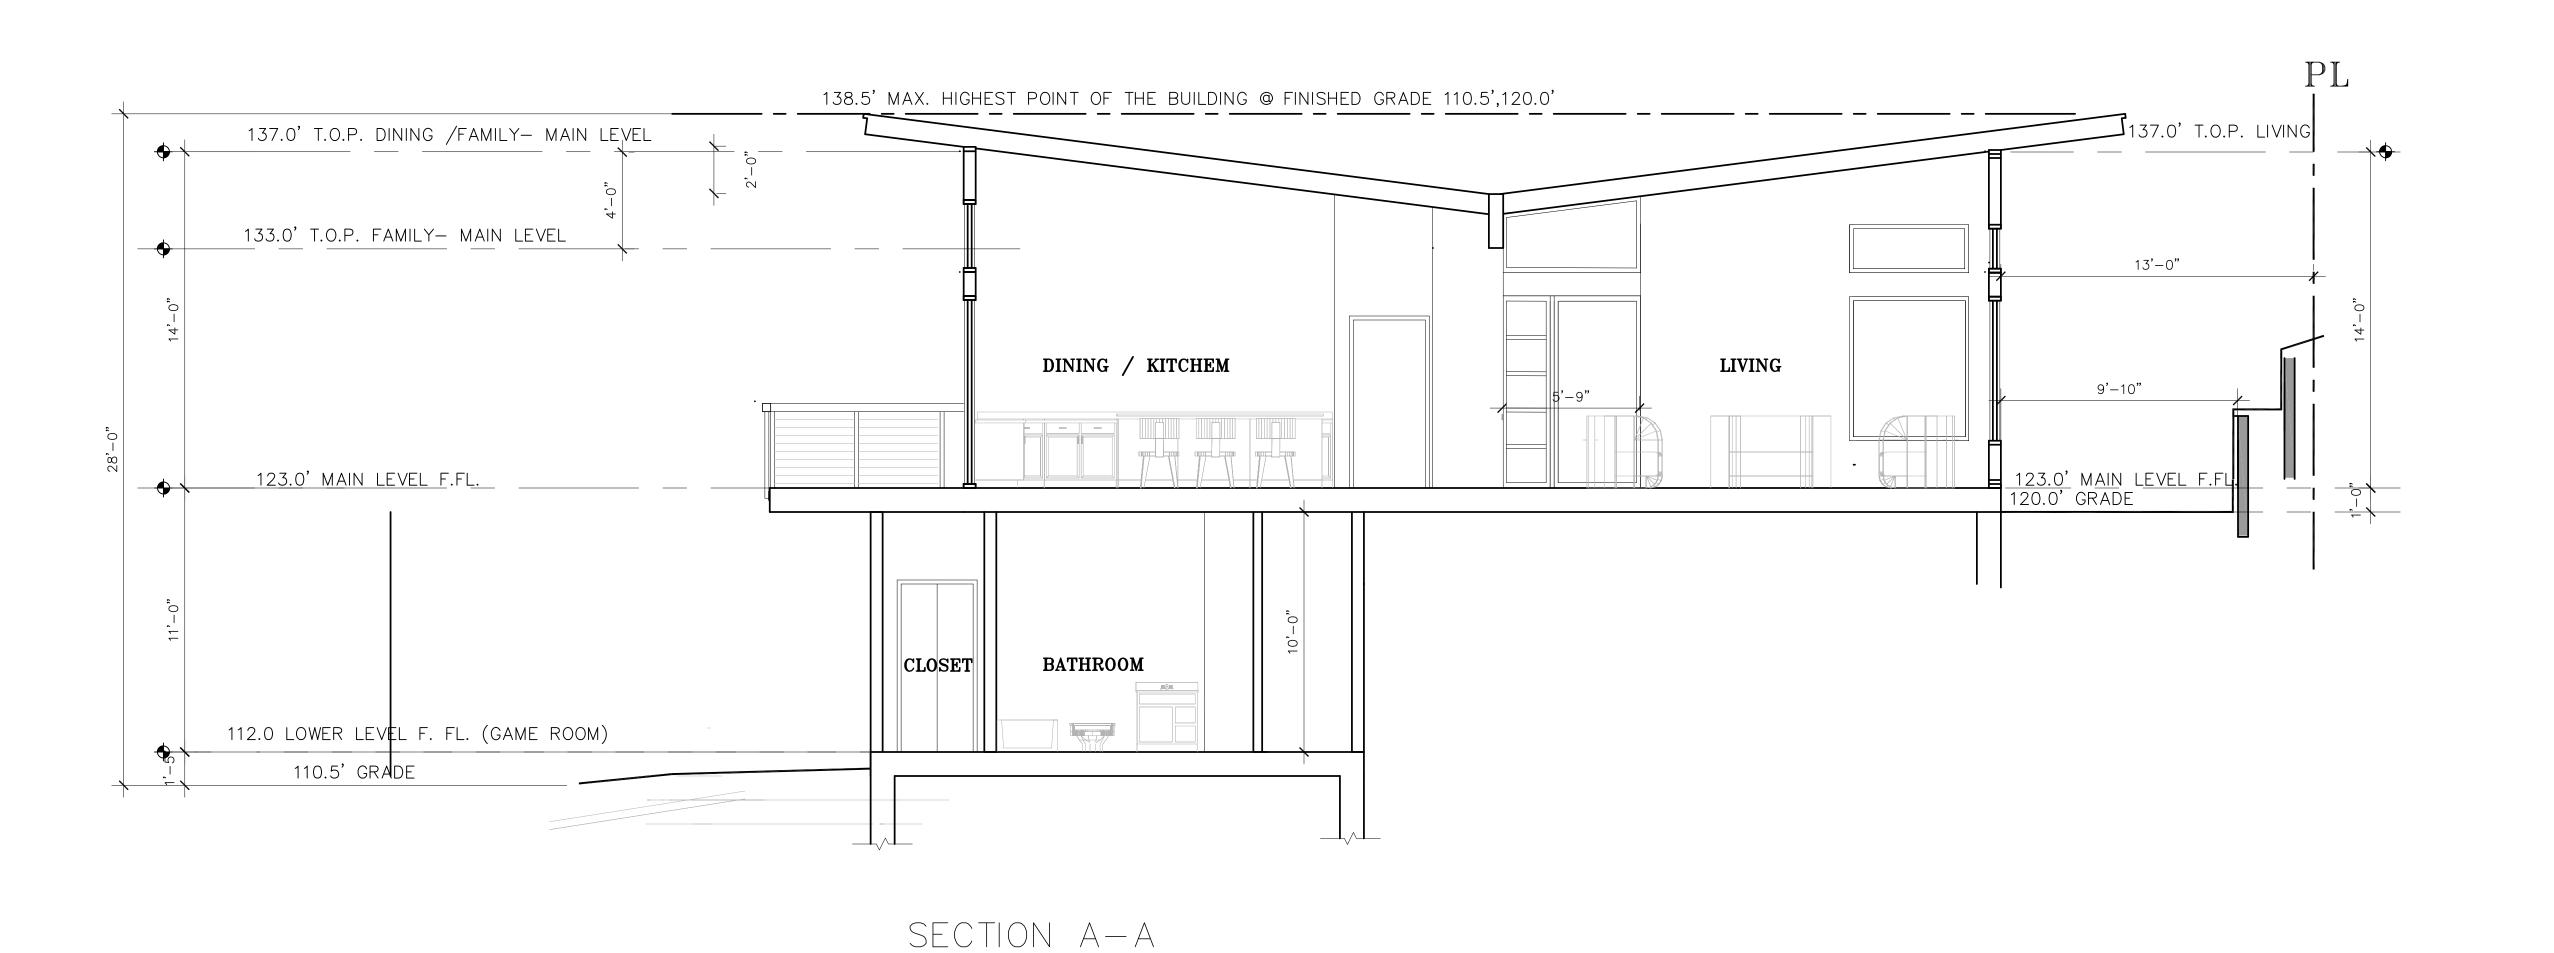

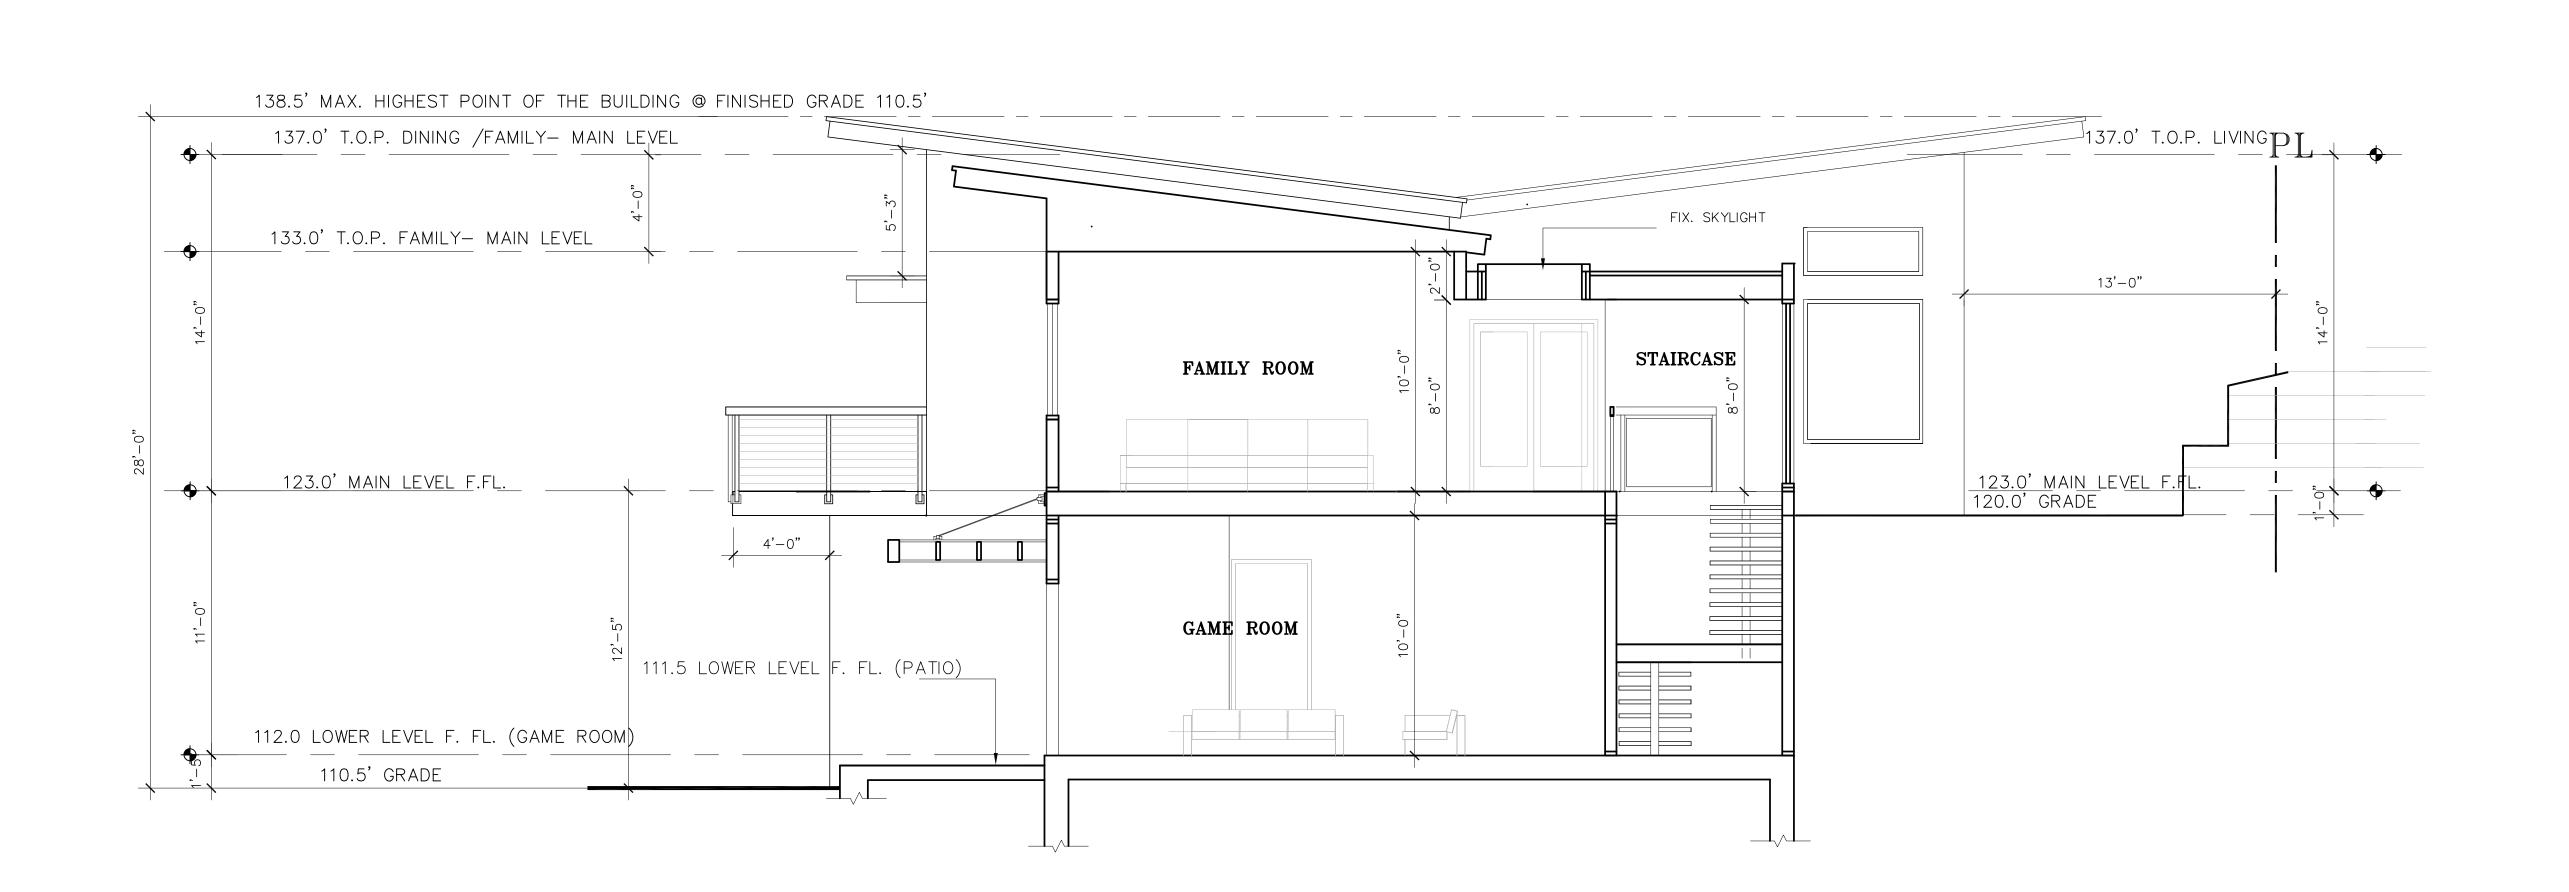



SECTION B-B

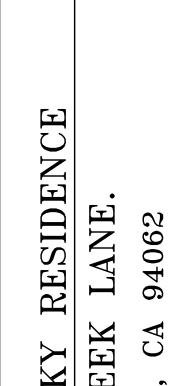


REVISION


Planning

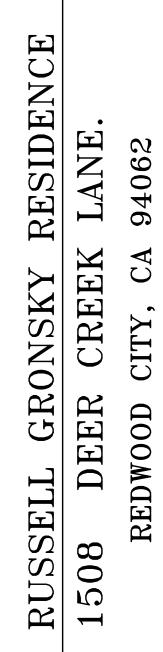

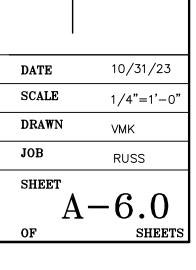

SECTIONS SCALE 1/4"=1'-0"

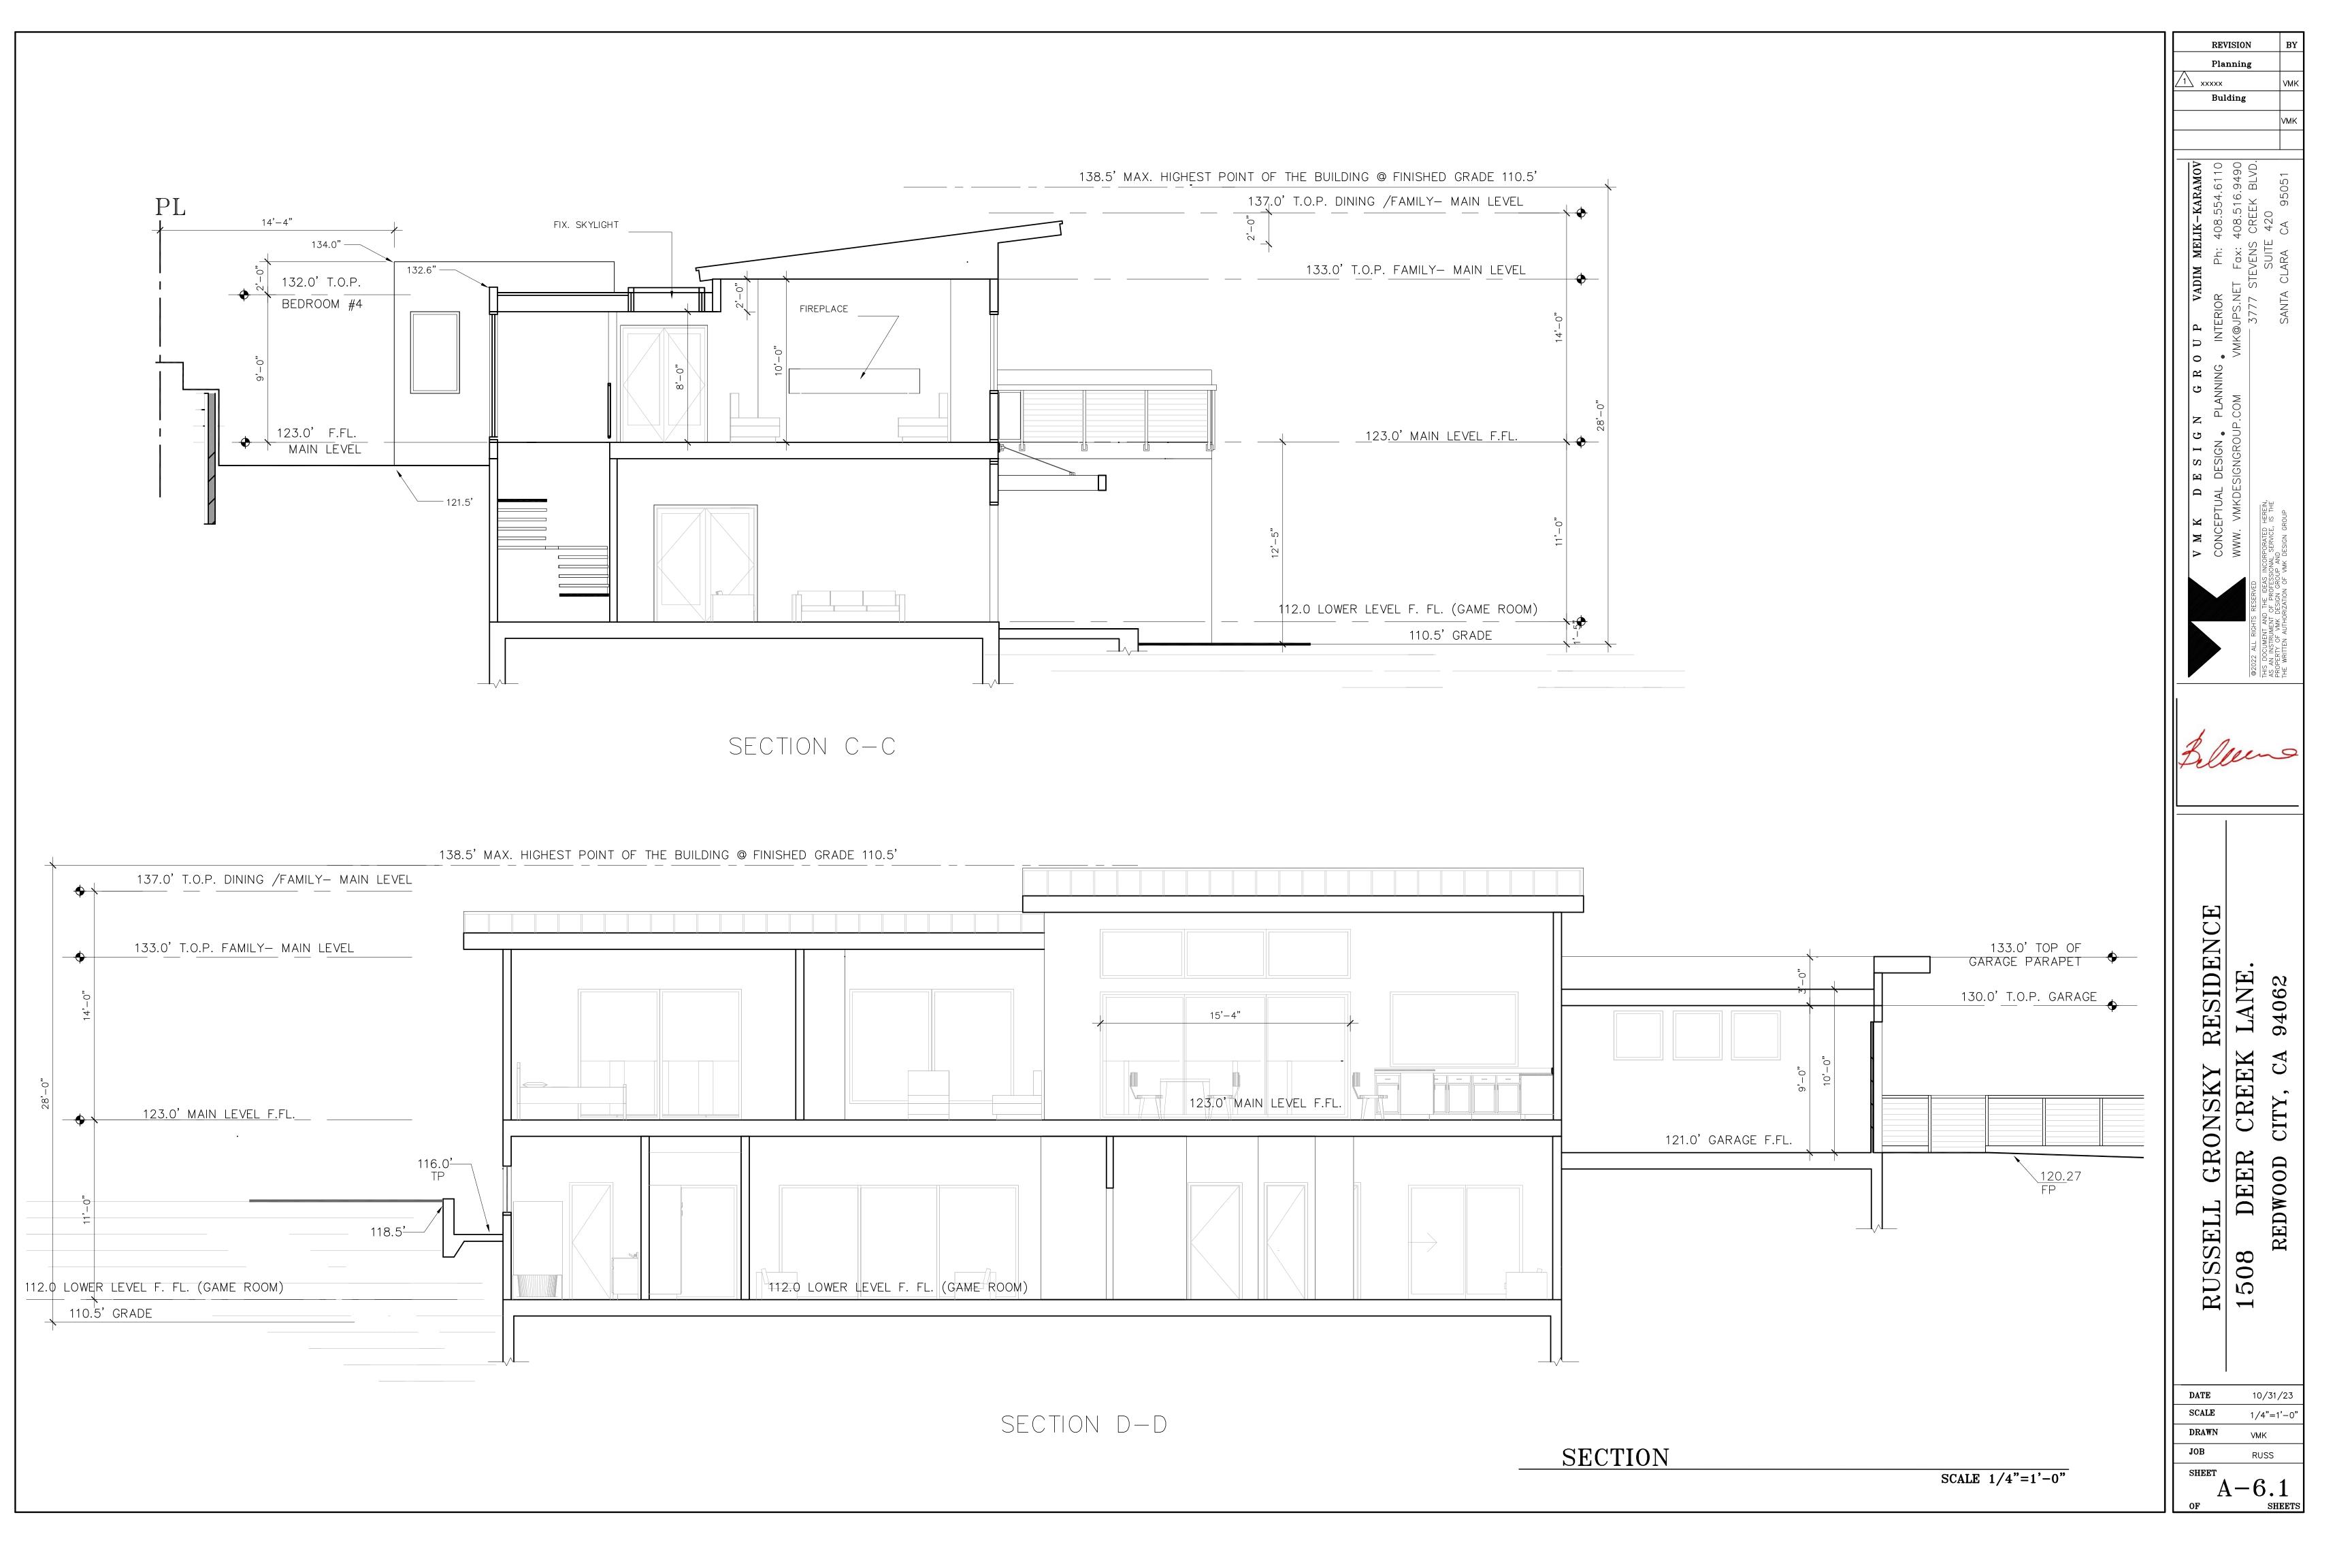

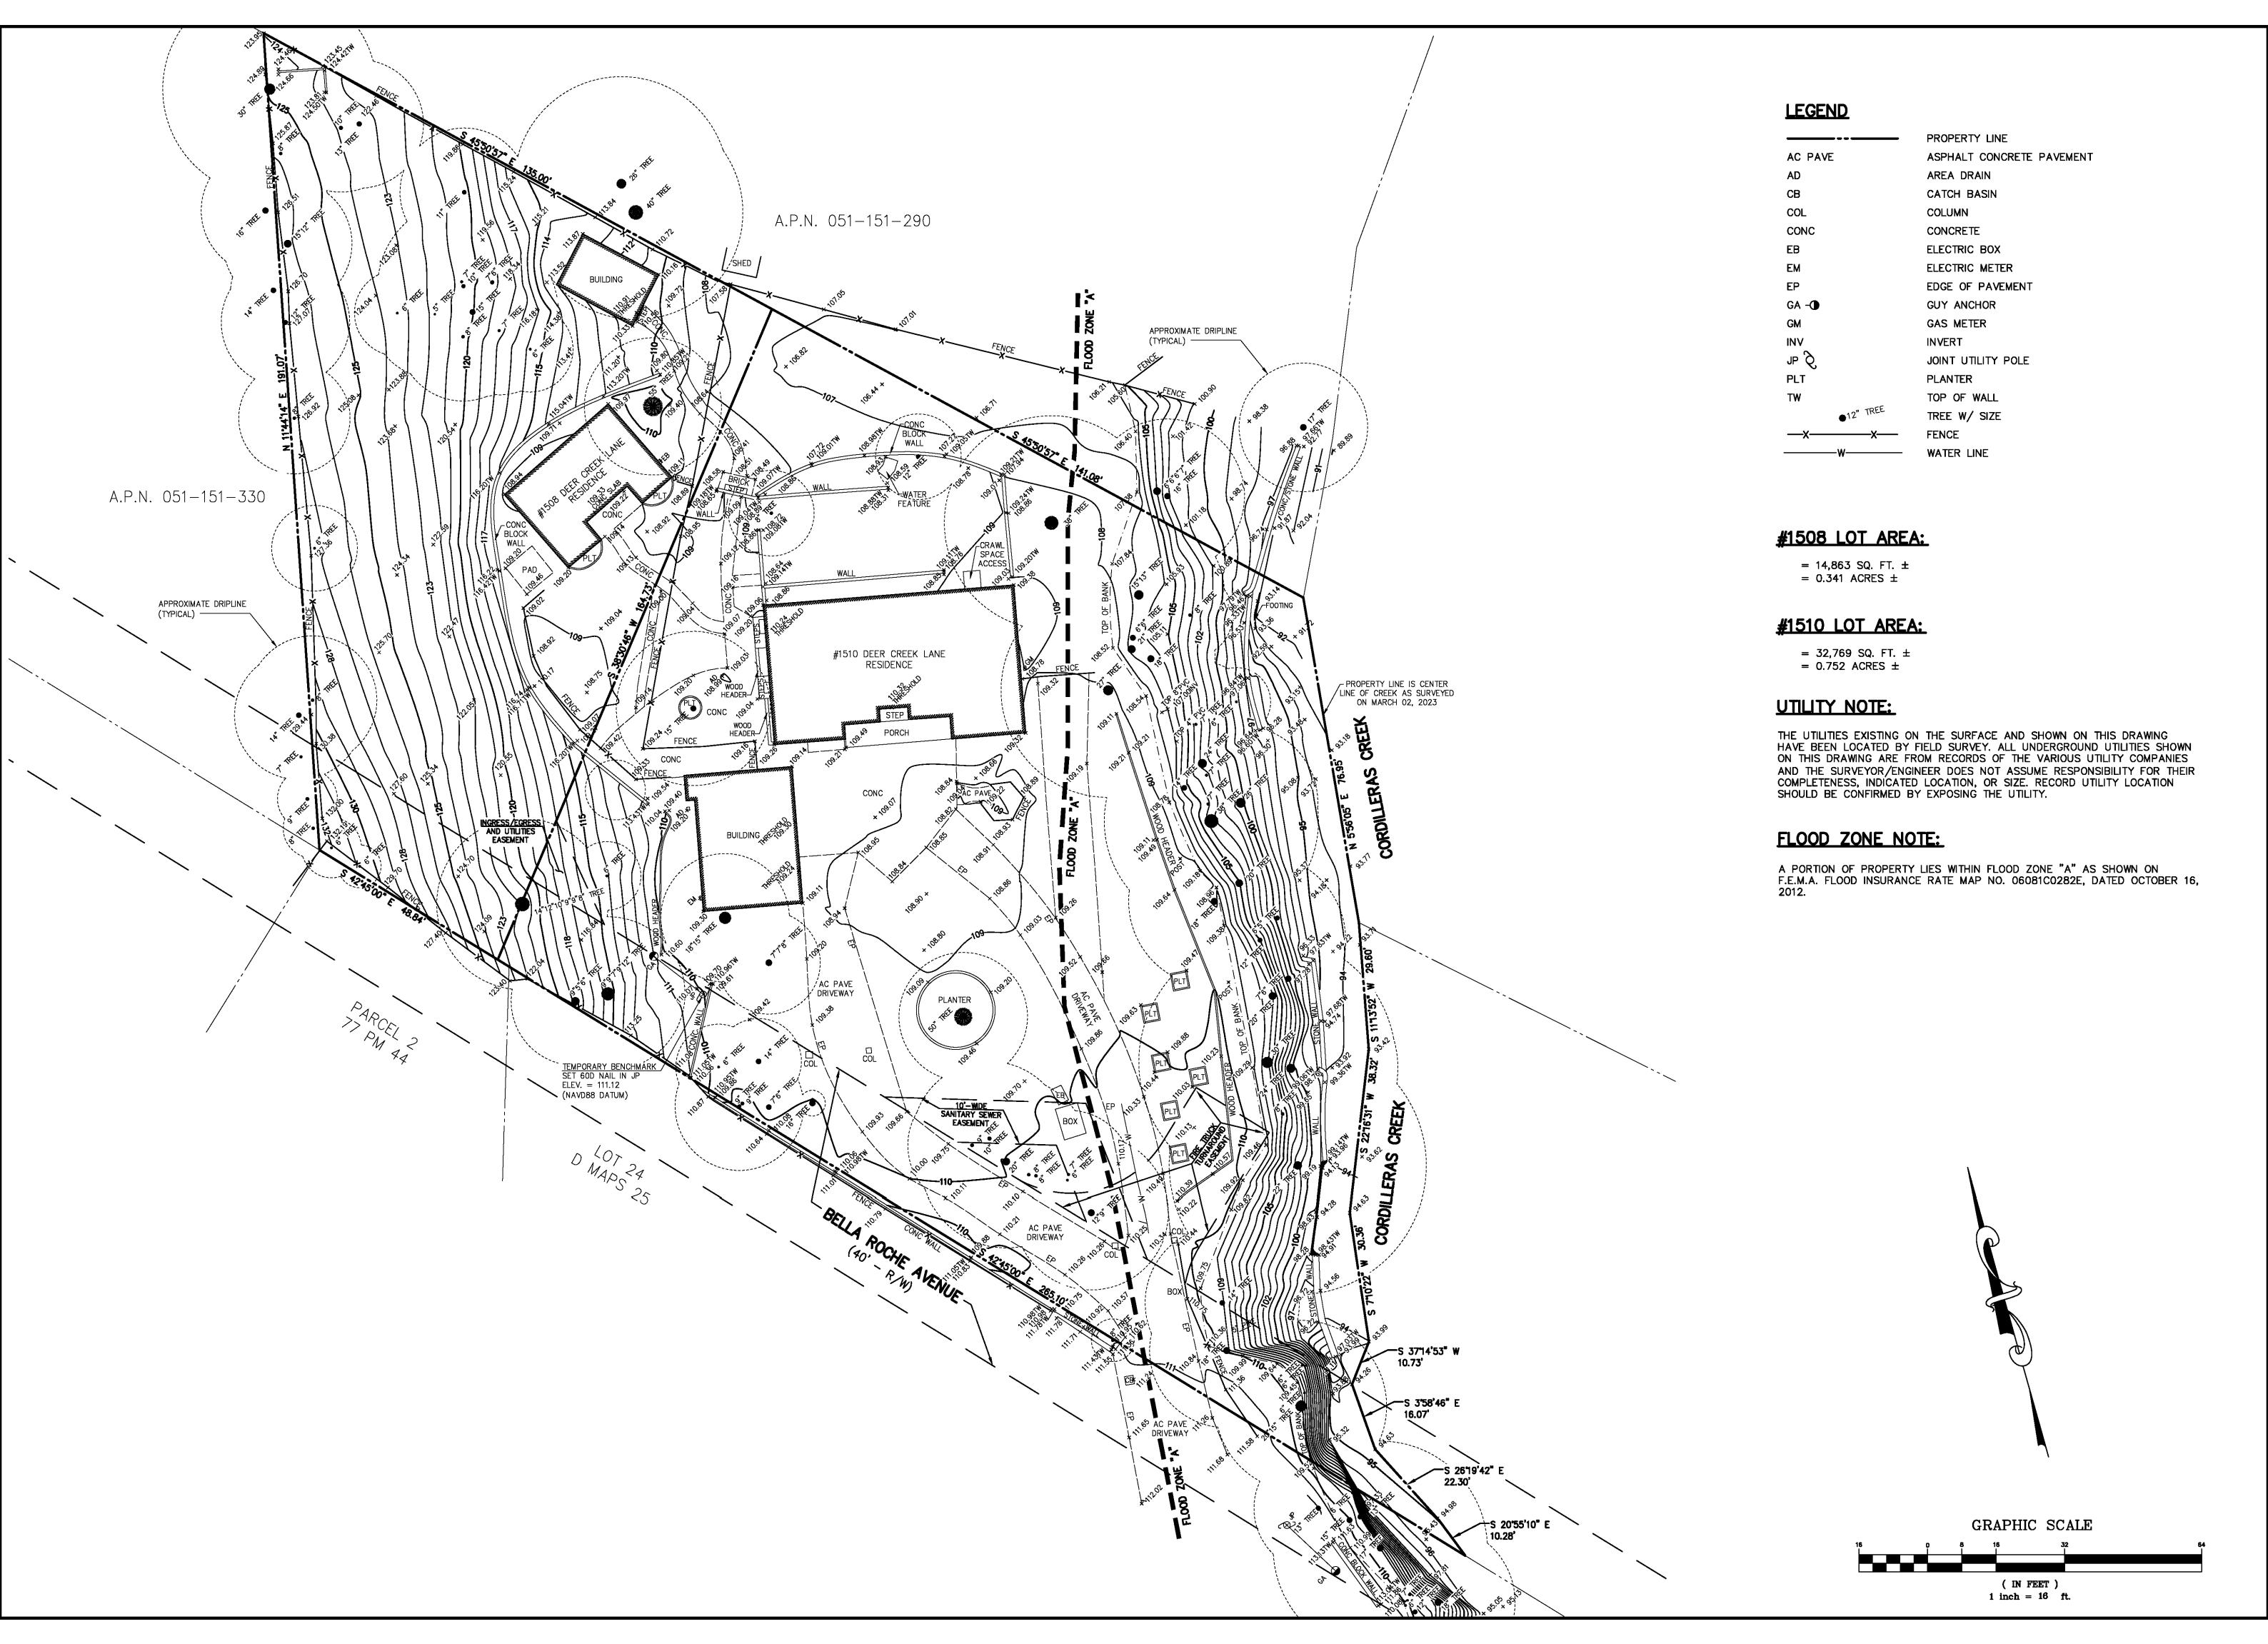

REV. DESCRIPTION BY:

No. 5304

CLEOD AND ASSOCIATES

CIVIL ENGINEERING · LAND SURVEYING

INTER STREET · SAN CARLOS · CA 94070 · (650) 593—85

SELL GRONSKY

CALIFORNIA

O DEER CREEK ROA 151–260 and 270 2004–059094 ATEO COUNTY

ARY AND TOPOGR 1508 AND 1510 DE A.P.N. 051-151-DOC. NO. 200

N BY: EM/ML


DRAWN BY: EM/ML
DESIGNED BY: --CHECKED BY: DGM

SCALE: 1"=16'
DATE: 03-29-23

DRAWING NO.
5402-TOPO

1 OF 1

SHEET

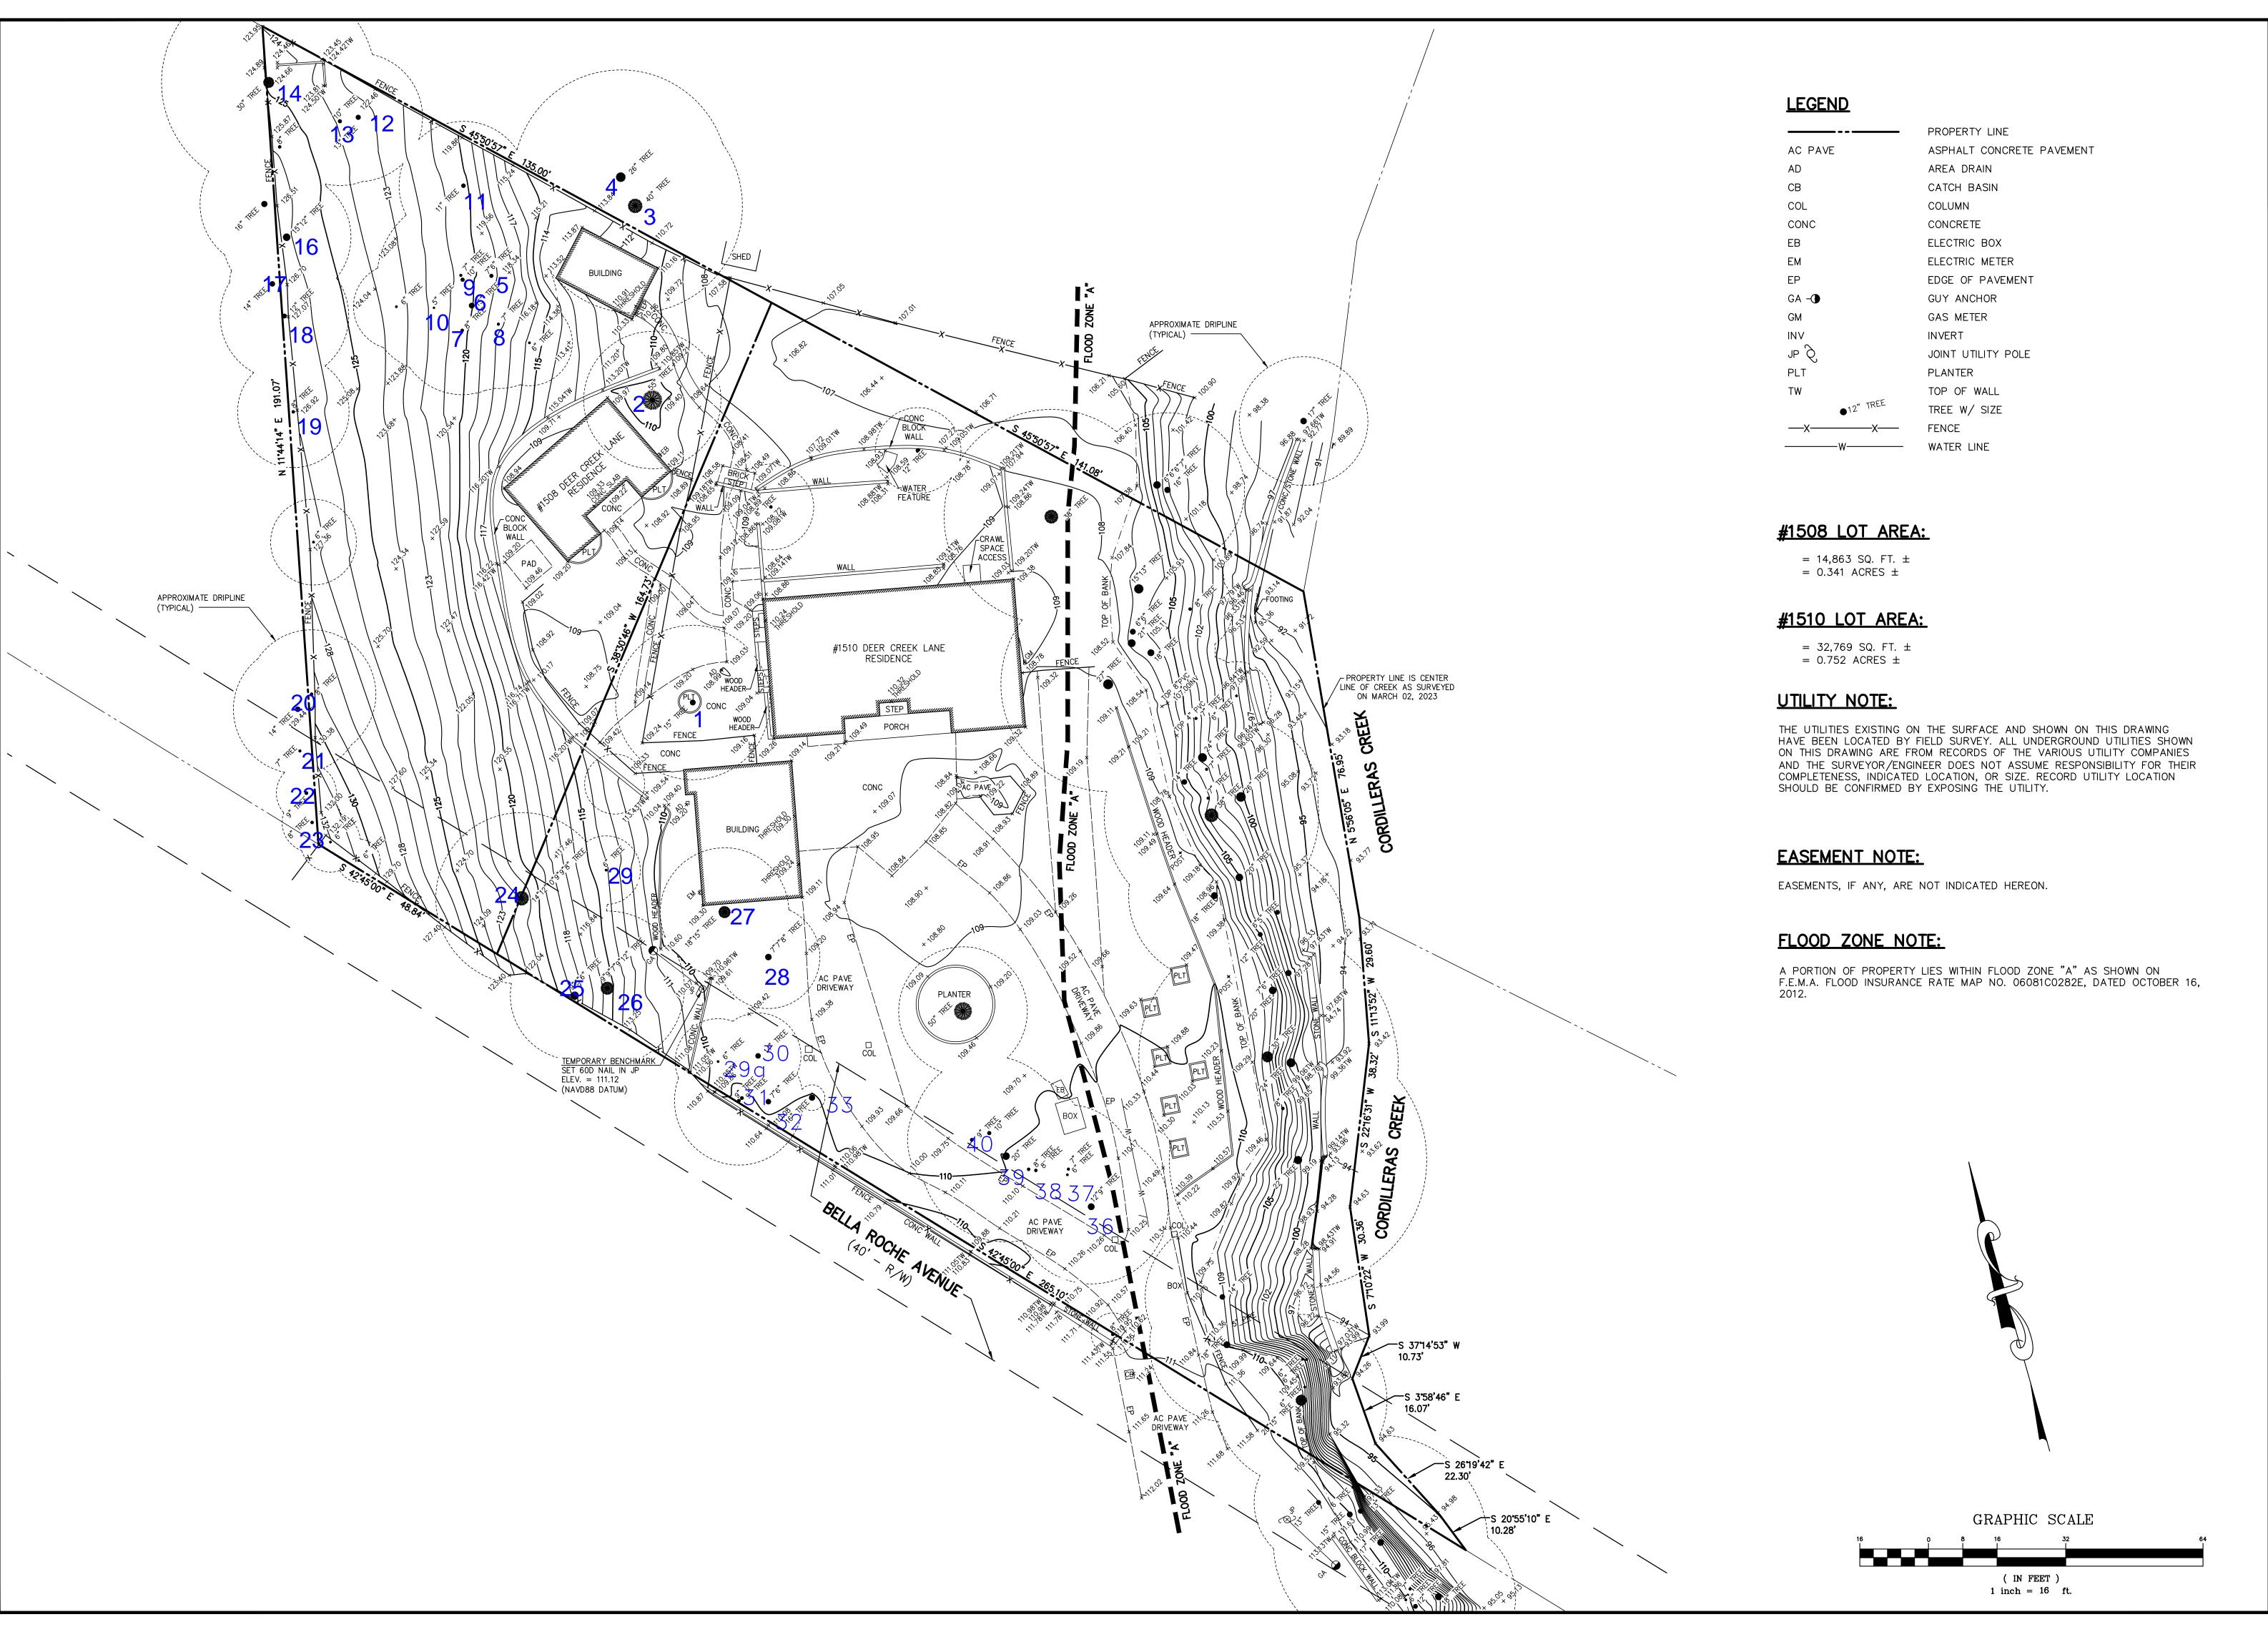

ASSOCIA

AND  $\square$ 

 Y AND TOPOGRAPHIC \$

 508 AND 1510 DEER CREEK

 A.P.N. 051-151-260 and

 DOC. NO. 2004-05909

 ED

 SAN MATEO COUNTY


BOUNDARY 150

DRAWN BY: EM/ML DESIGNED BY: ---CHECKED BY: DGM SCALE: 1"=16' DATE: 03-09-23

DRAWING NO. 5402-TOPO

1 OF 1

SHEET

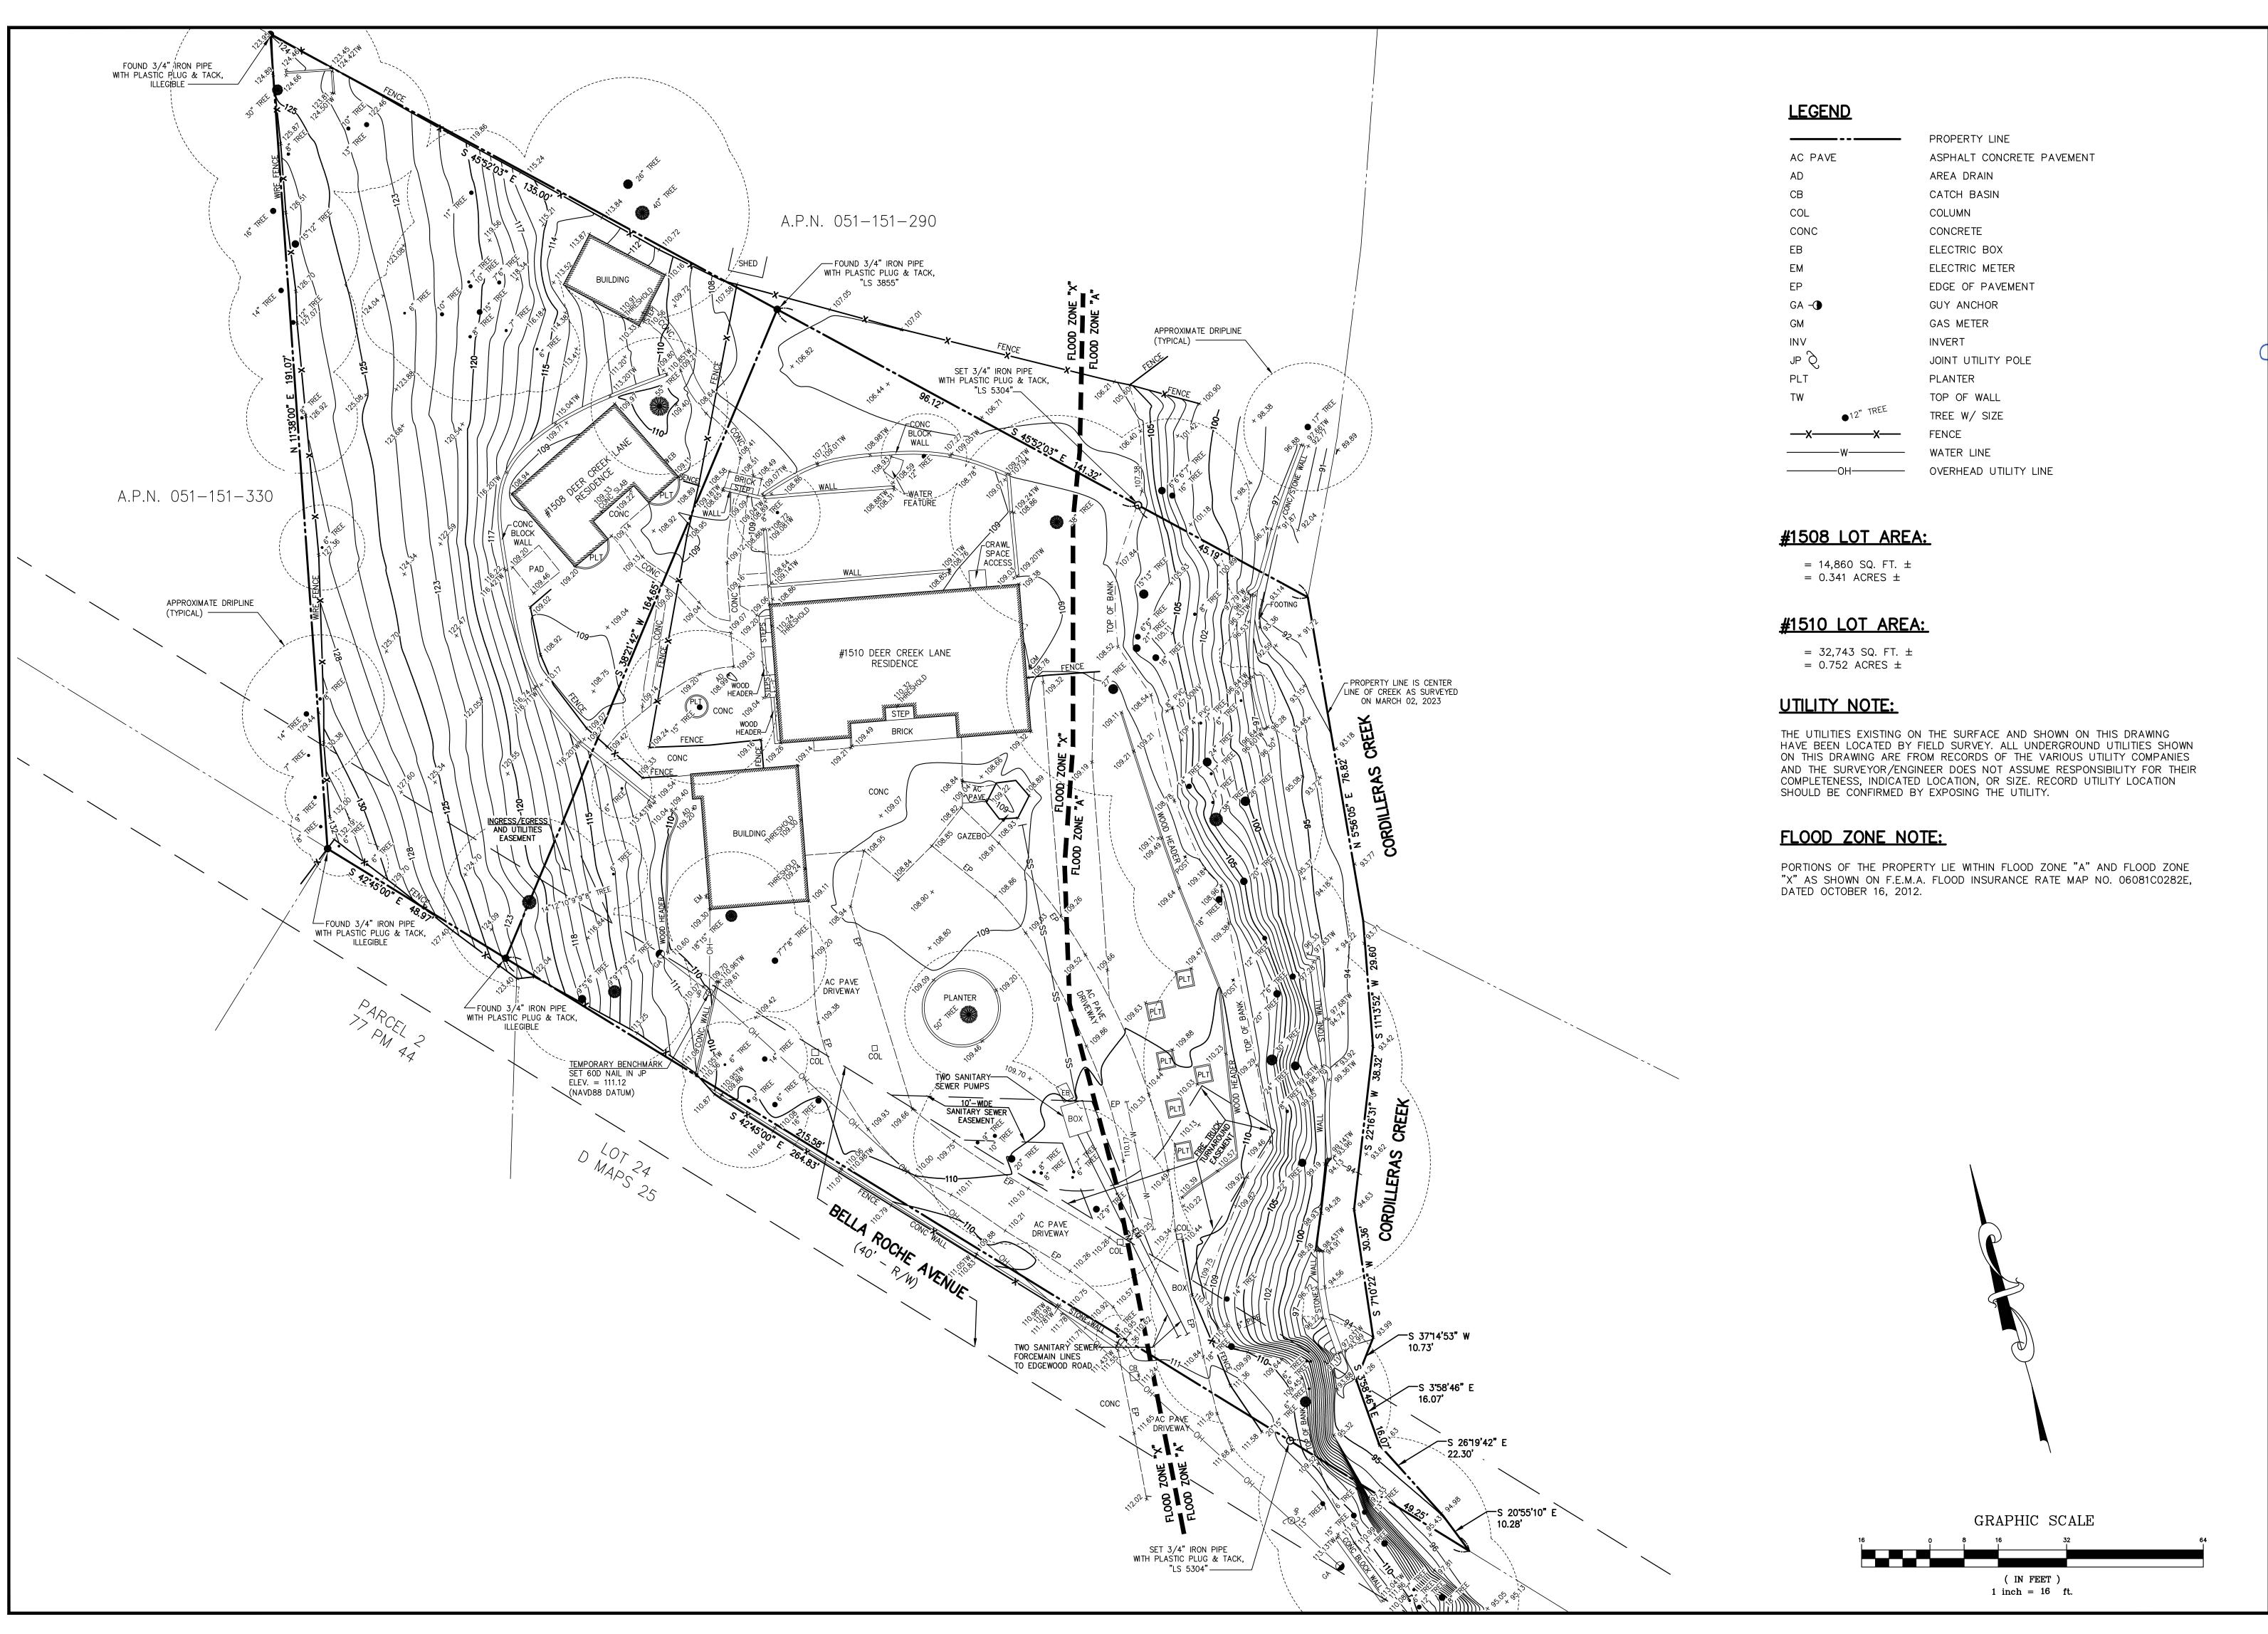

REV. DESCRIPTION



10 ASSOCIATES
NG.LAND SURVEYING
CARLOS.CA 94070.(650) 593-85

MACLEOD AND
CIVIL ENGINEERING.

965 CENTER STREET.SAN CARL

SSELL GRONSKY

COUNTY CALIFORNIA

08 AND 1510 DEER CA.P.N. 051-151-260 DOC. NO. 2004-050 DOC. NO. 2004-050 DOC.

150 A UNINCORPORATEI

DRAWN BY: EM/ML

DESIGNED BY: --
CHECKED BY: DGM

CHECKED BY: DGM

SCALE: 1"=16'

DATE: 04-25-23


DRAWING NO.


DRAWING NO.


5402-TOPO

SHEET

**C-1**1 OF 5

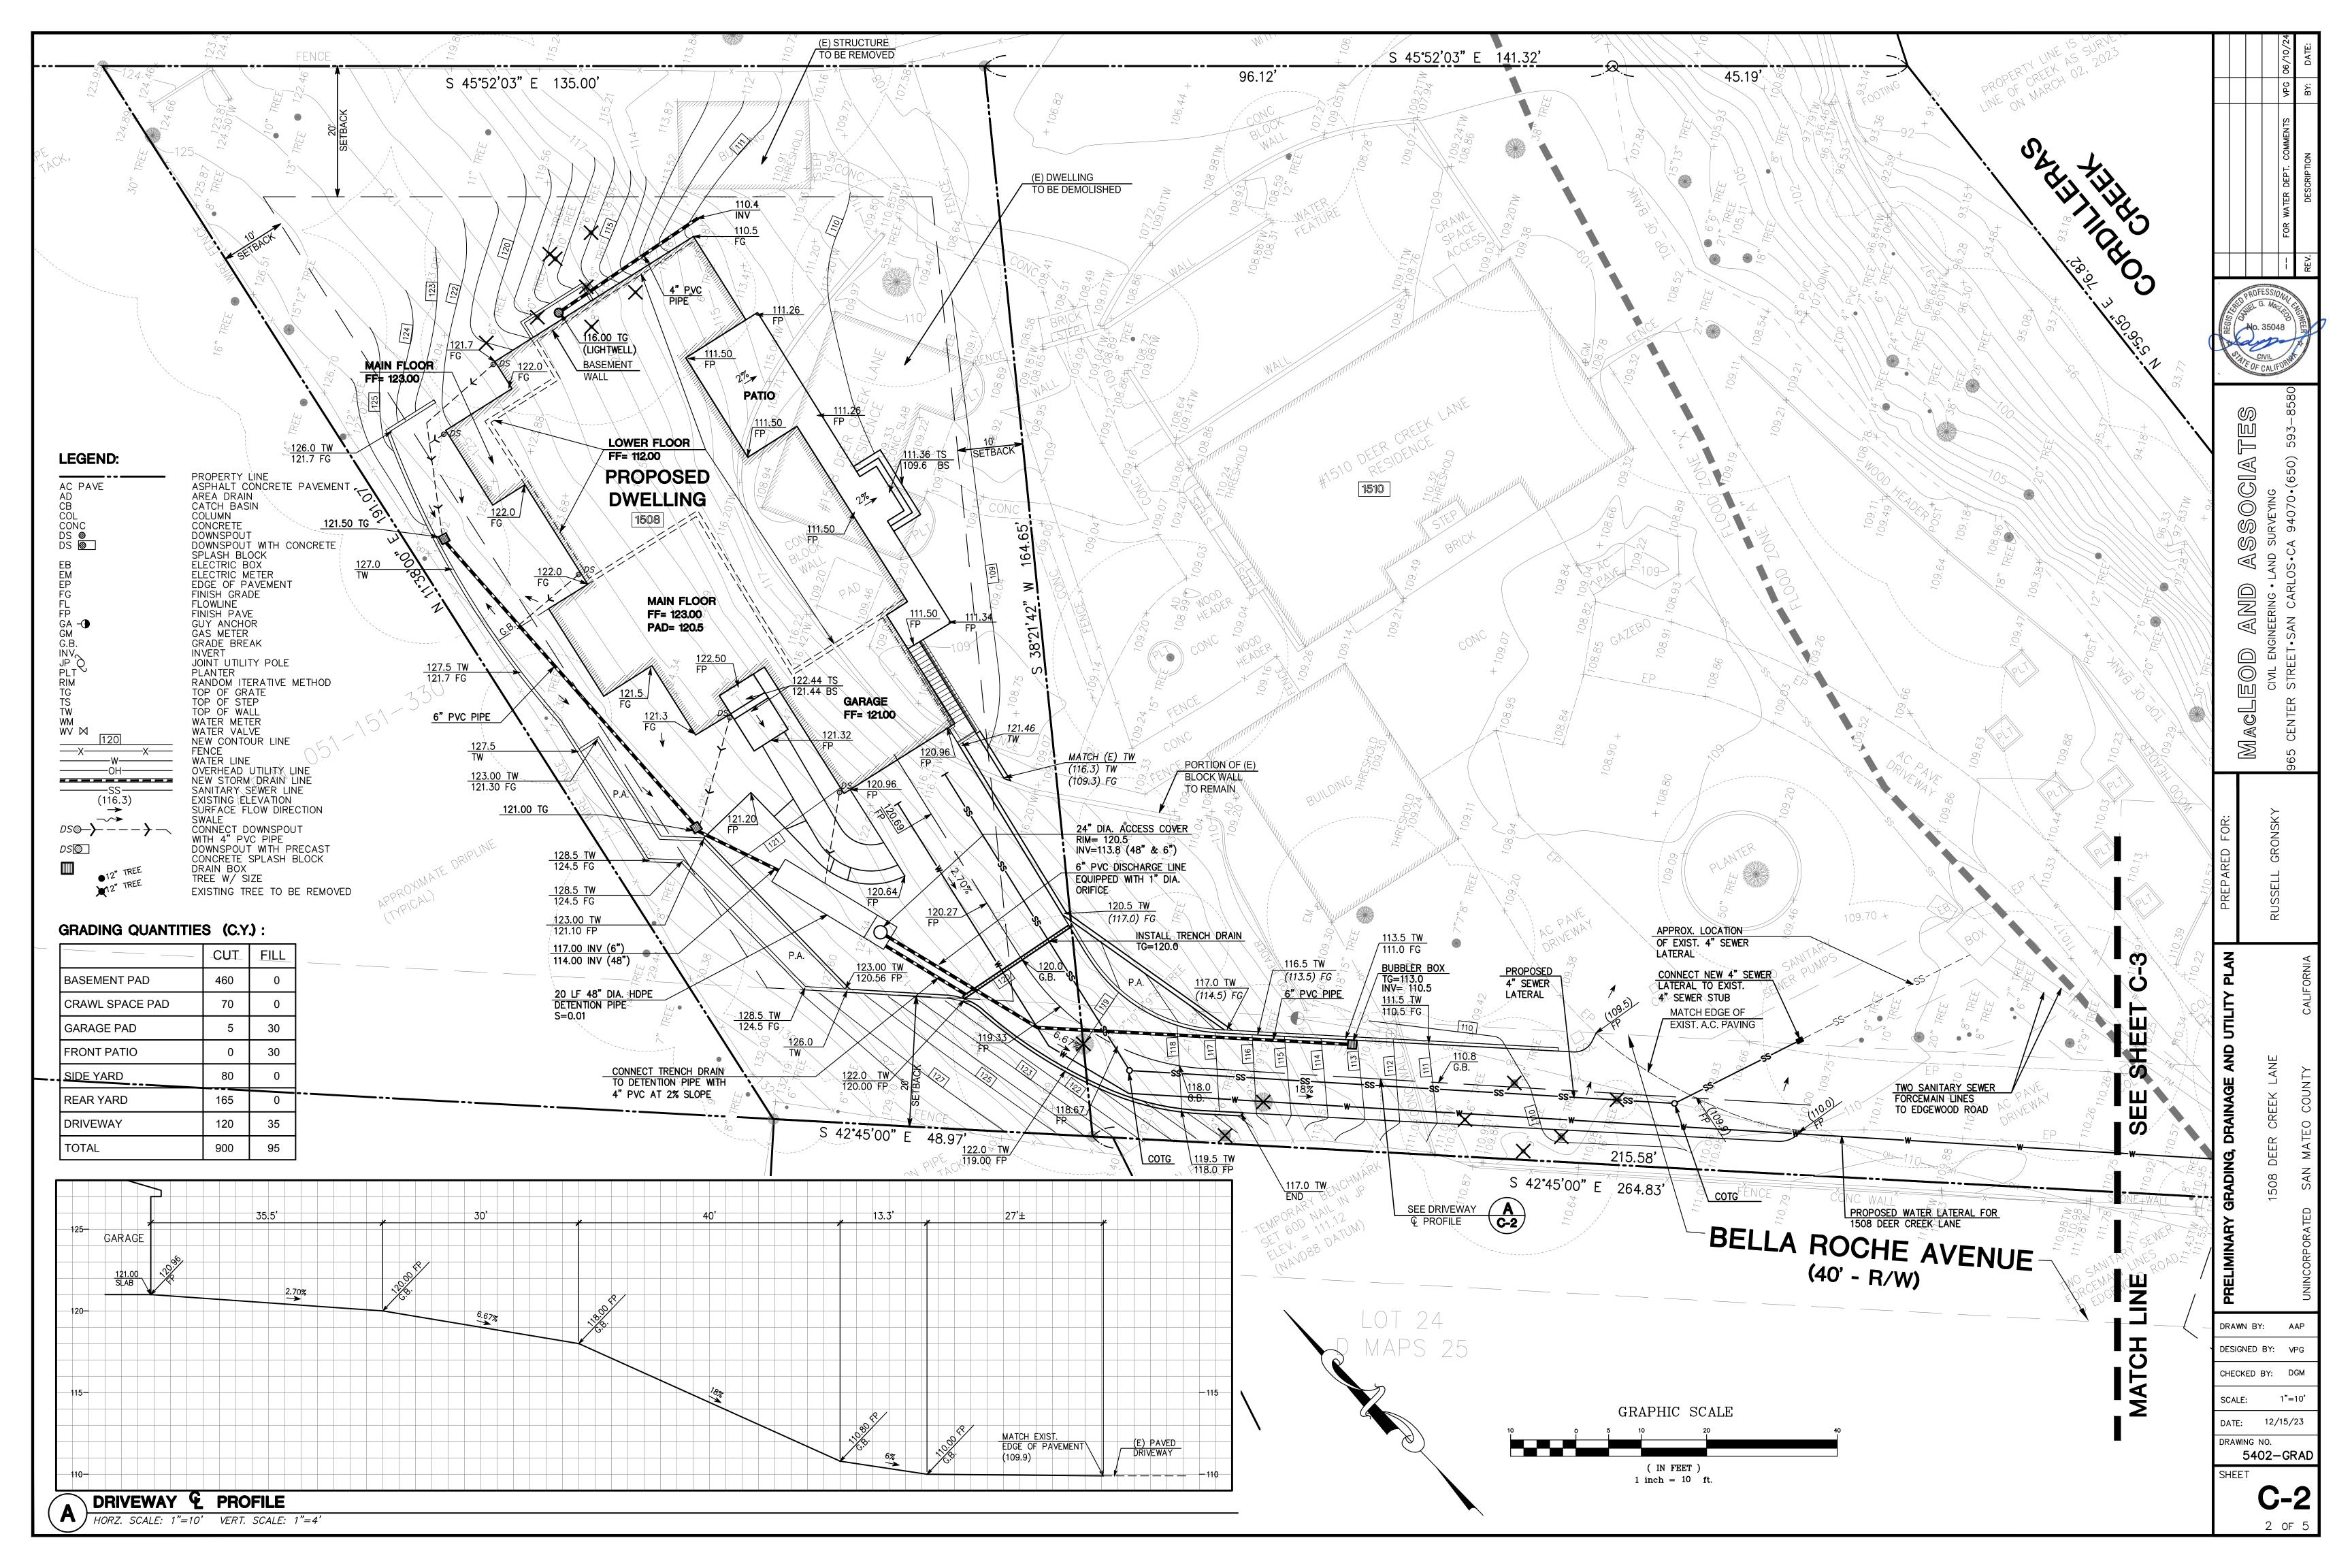

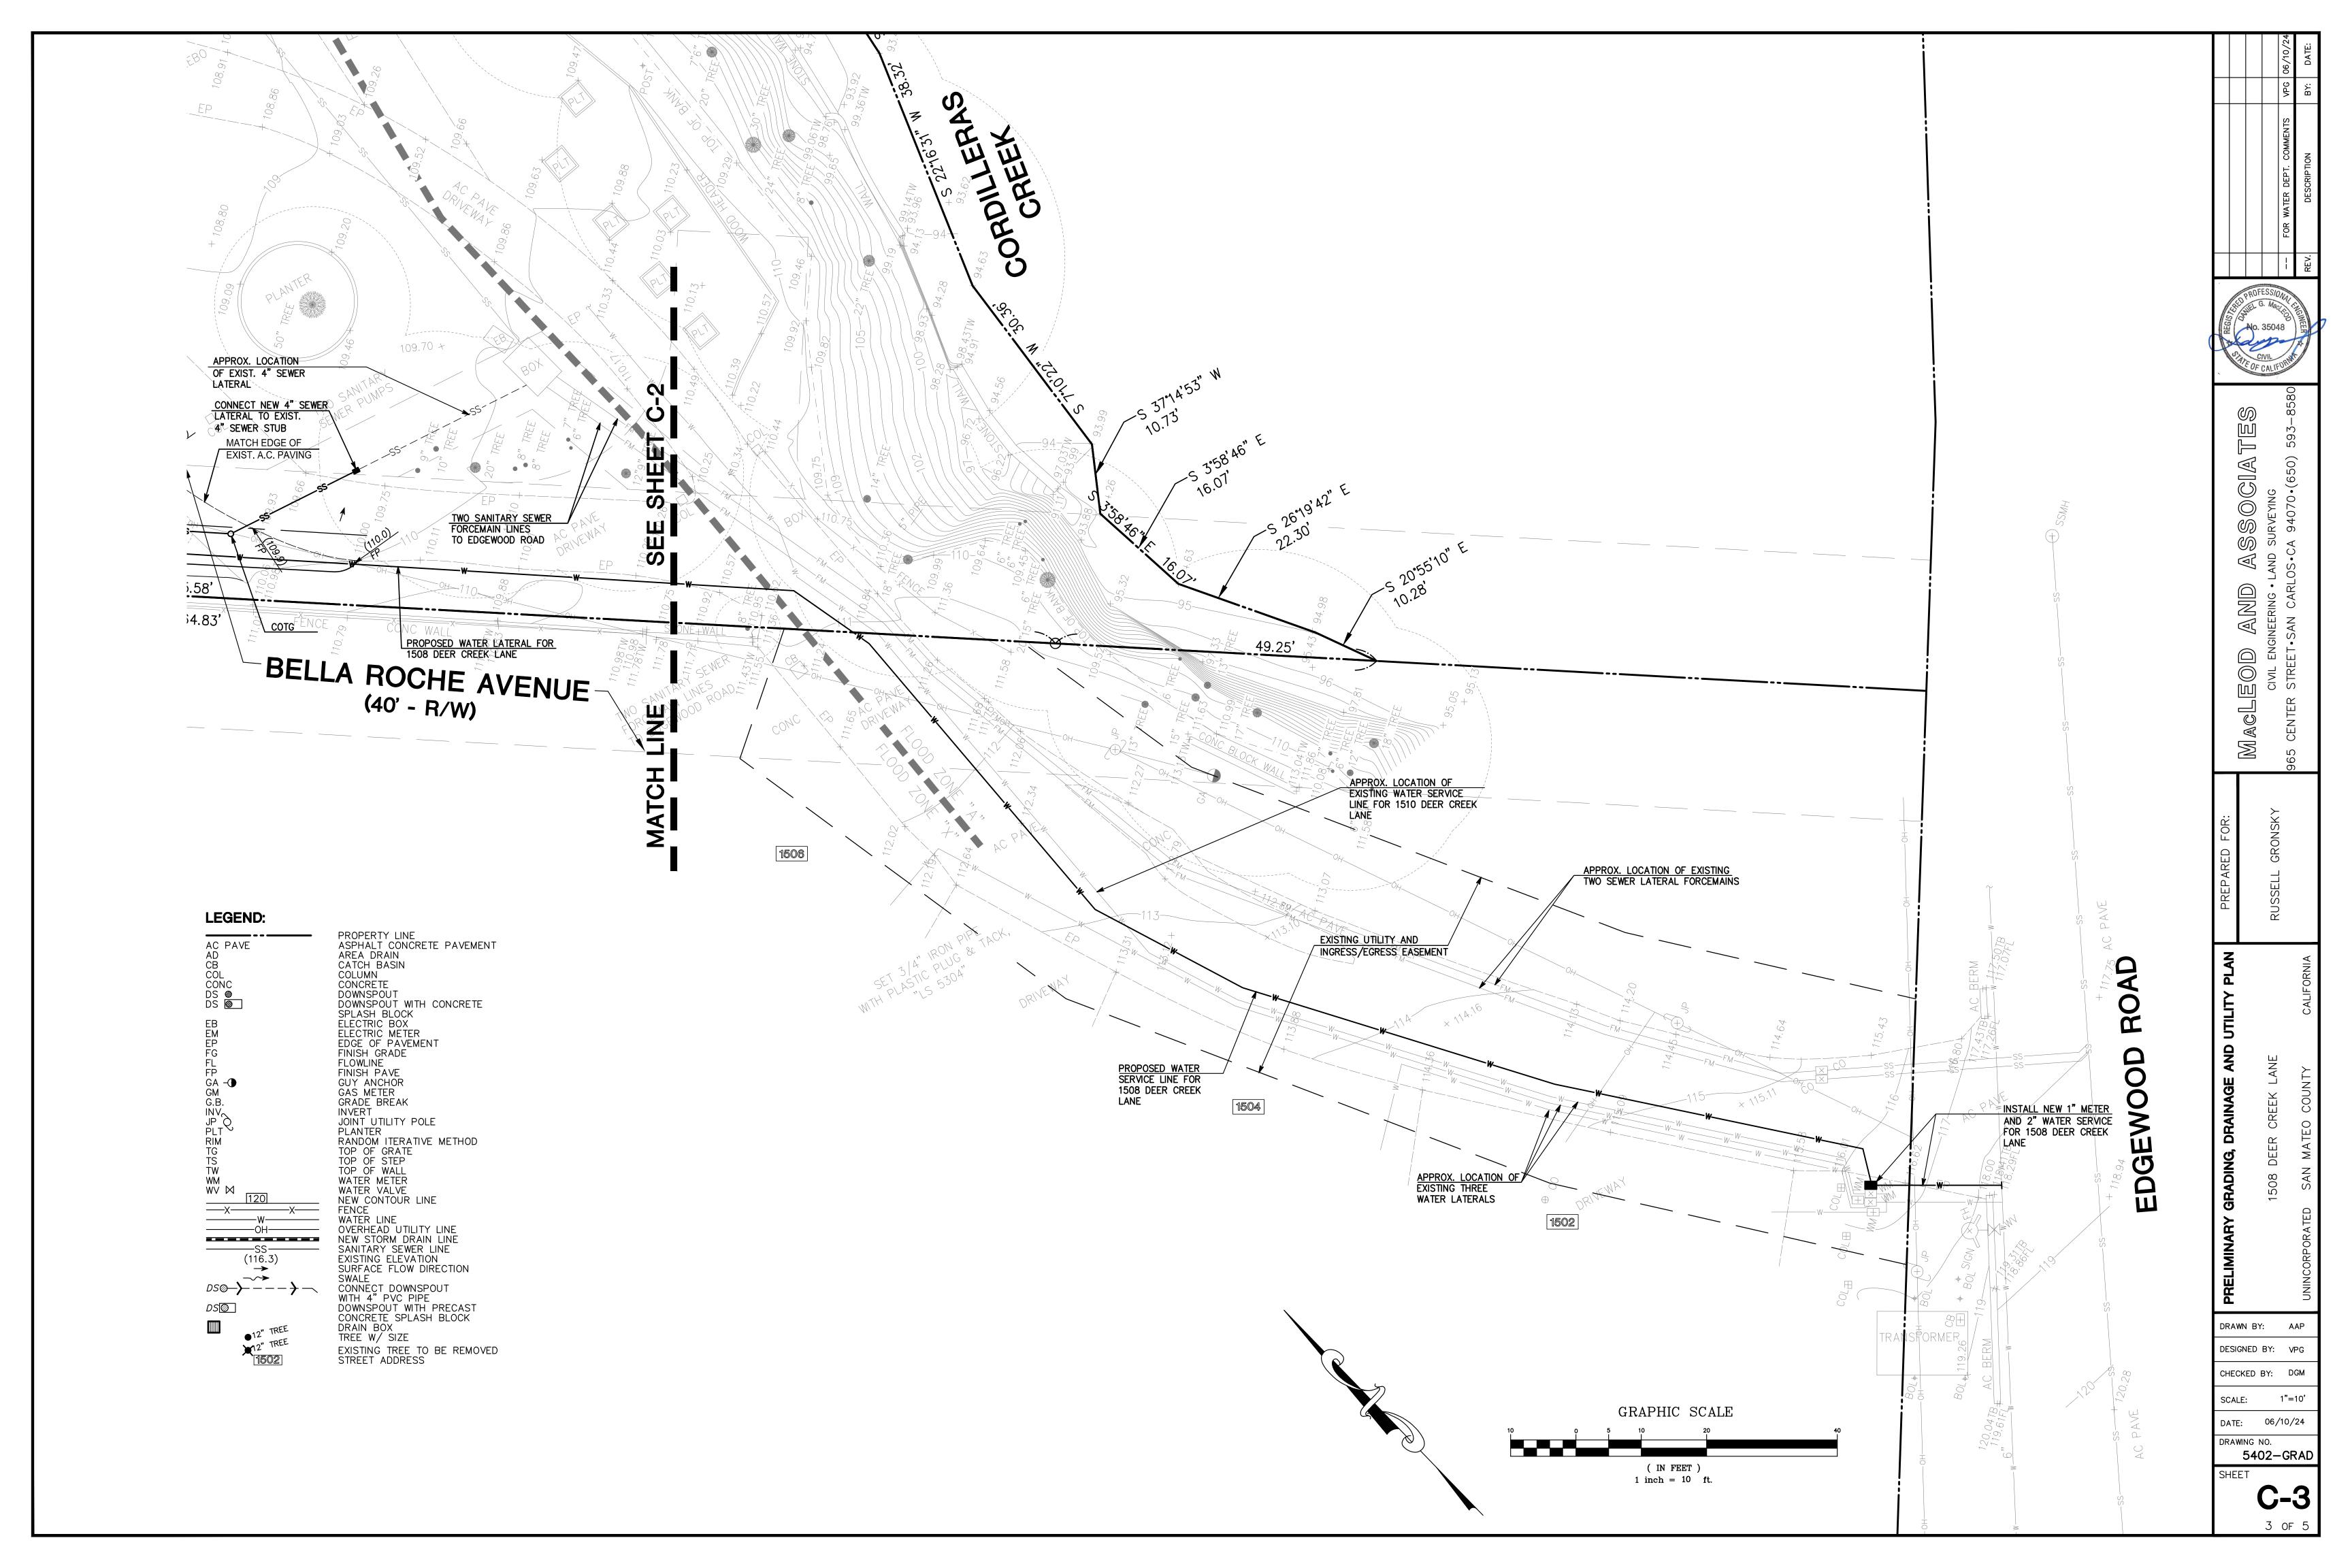

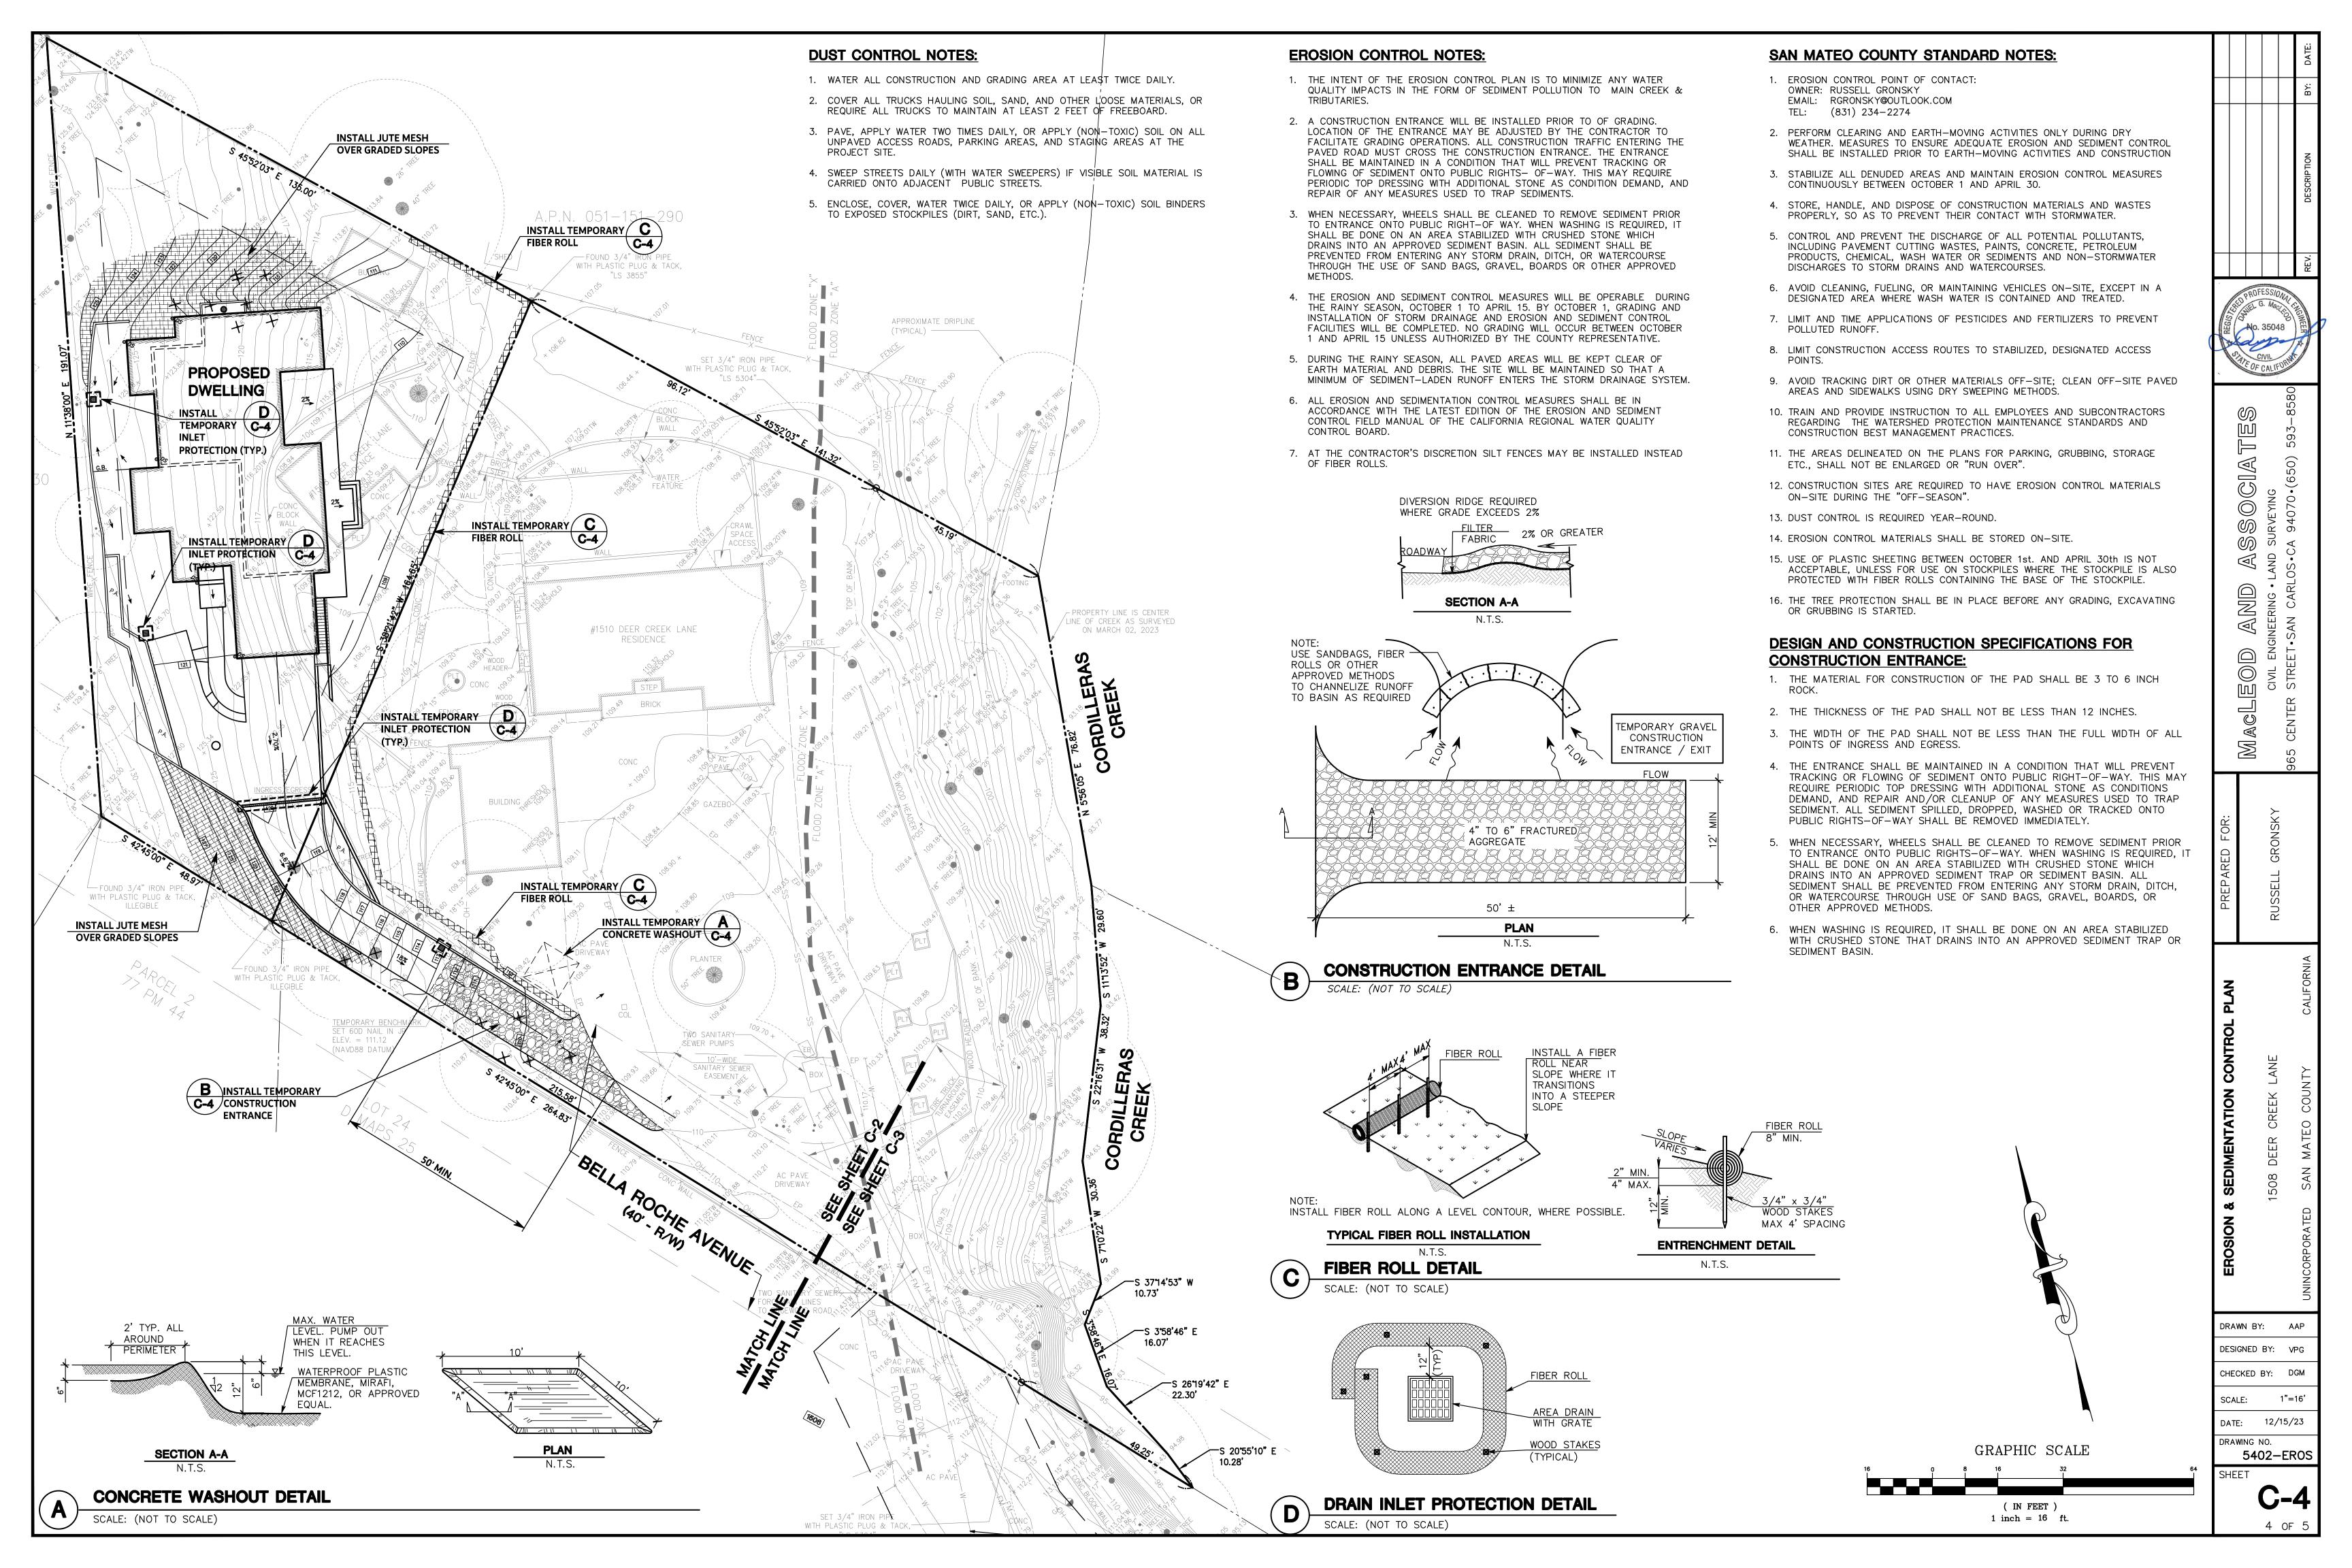




# Construction Best Management Practices (BMPs)

Construction projects are required to implement the stormwater best management practices (BMP) on this page, as they apply to your project, all year long.

Clean Water. Healthy Community.

### Materials & Waste Management

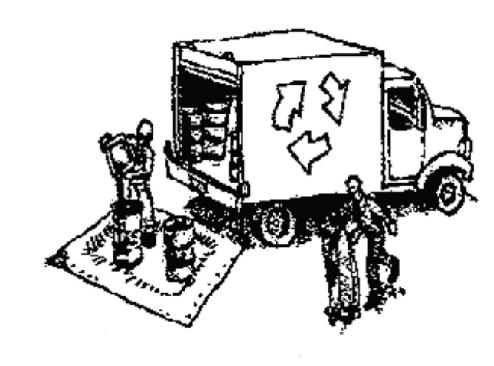

#### **Non-Hazardous Materials**

- ☐ Berm and cover stockpiles of sand, dirt or other construction material with tarps when rain is forecast or if not actively being used within 14 days.
- ☐ Use (but don't overuse) reclaimed water for dust control

### **Hazardous Materials**

- ☐ Label all hazardous materials and hazardous wastes (such as pesticides, paints, thinners, solvents, fuel, oil, and antifreeze) in accordance with city, county, state and federal regulations.
- ☐ Store hazardous materials and wastes in water tight containers, store in appropriate secondary containment, and cover them at the end of every work day or during wet weather or when rain is forecast.
- ☐ Follow manufacturer's application instructions for hazardous materials and be careful not to use more than necessary. Do not apply chemicals outdoors when rain is forecast within 24 hours.
- ☐ Arrange for appropriate disposal of all hazardous wastes.

### Waste Management

- ☐ Cover waste disposal containers securely with tarps at the end of every work day and during wet weather.
- ☐ Check waste disposal containers frequently for leaks and to make sure they are not overfilled. Never hose down a dumpster on the construction site.
- ☐ Clean or replace portable toilets, and inspect them frequently for leaks and spills.
- ☐ Dispose of all wastes and debris properly. Recycle materials and wastes that can be recycled (such as asphalt, concrete, aggregate base materials, wood, gyp board, pipe, etc.)
- ☐ Dispose of liquid residues from paints, thinners, solvents, glues, and cleaning fluids as hazardous waste.

### **Construction Entrances and Perimeter**

- ☐ Establish and maintain effective perimeter controls and stabilize all construction entrances and exits to sufficiently control erosion and sediment discharges from site and tracking off site.
- ☐ Sweep or vacuum any street tracking immediately and secure sediment source to prevent further tracking. Never hose down streets to clean up tracking.

# **Equipment Management & Spill Control**




### Maintenance and Parking

- ☐ Designate an area, fitted with appropriate BMPs, for vehicle and equipment parking and storage.
- ☐ Perform major maintenance, repair jobs, and vehicle and equipment washing off site.
- ☐ If refueling or vehicle maintenance must be done onsite, work in a bermed area away from storm drains and over a drip pan or drop cloths big enough to collect fluids. Recycle or dispose of fluids as hazardous waste.
- ☐ If vehicle or equipment cleaning must be done onsite, clean with water only in a bermed area that will not allow rinse water to run into gutters, streets, storm drains, or surface waters.
- ☐ Do not clean vehicle or equipment onsite using soaps, solvents, degreasers, or steam cleaning equipment.

### **Spill Prevention and Control**

- ☐ Keep spill cleanup materials (e.g., rags, absorbents and cat litter) available at the construction site at all times.
- ☐ Inspect vehicles and equipment frequently for and repair leaks promptly. Use drip pans to catch leaks until repairs are made.
- ☐ Clean up spills or leaks immediately and dispose of cleanup materials properly.
- ☐ Do not hose down surfaces where fluids have spilled. Use dry cleanup methods (absorbent materials, cat litter, and/or rags).
- Sweep up spilled dry materials immediately. Do not try to wash them away with water, or bury them.
- ☐ Clean up spills on dirt areas by digging up and properly disposing of contaminated soil.
- □ Report significant spills immediately. You are required by law to report all significant releases of hazardous materials, including oil. To report a spill: 1) Dial 911 or your local emergency response number, 2) Call the Governor's Office of Emergency Services Warning Center, (800) 852-7550 (24 hours).

### **Earthmoving**

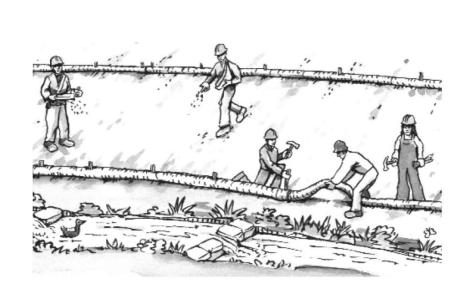

- ☐ Schedule grading and excavation work during dry weather.
- ☐ Stabilize all denuded areas, install and maintain temporary erosion controls (such as erosion control fabric or bonded fiber matrix) until vegetation is established.
- ☐ Remove existing vegetation only when absolutely necessary, and seed or plant vegetation for erosion control on slopes or where construction is not immediately planned.
- ☐ Prevent sediment from migrating offsite and protect storm drain inlets, gutters, ditches, and drainage courses by installing and maintaining appropriate BMPs, such as fiber rolls, silt fences, sediment basins, gravel bags, berms, etc.
- ☐ Keep excavated soil on site and transfer it to dump trucks on site, not in the streets.

### **Contaminated Soils**

- ☐ If any of the following conditions are observed, test for contamination and contact the Regional Water Quality Control Board:
- Unusual soil conditions, discoloration, or odor.
- Abandoned underground tanks.
- Abandoned wells
- Buried barrels, debris, or trash.

### Paving/Asphalt Work




- Avoid paving and seal coating in wet weather or when rain is forecast, to prevent materials that have not cured from contacting stormwater runoff.
- ☐ Cover storm drain inlets and manholes when applying seal coat, tack coat, slurry seal, fog seal, etc.
- ☐ Collect and recycle or appropriately dispose of excess abrasive gravel or sand. Do NOT sweep or wash it into gutters.
- ☐ Do not use water to wash down fresh asphalt concrete pavement.

### Sawcutting & Asphalt/Concrete Removal

- ☐ Protect nearby storm drain inlets when saw cutting. Use filter fabric, catch basin inlet filters, or gravel bags to keep slurry out of the storm drain system.
- ☐ Shovel, abosorb, or vacuum saw-cut slurry and dispose of all waste as soon as you are finished in one location or at the end of each work day (whichever is sooner!).
- ☐ If sawcut slurry enters a catch basin, clean it up immediately.

## Concrete, Grout & Mortar Application

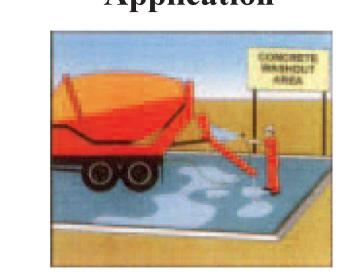


☐ Store concrete, grout, and mortar away from storm drains or waterways, and on pallets under cover to protect them from rain, runoff, and wind.

☐ Wash out concrete equipment/trucks


- offsite or in a designated washout area, where the water will flow into a temporary waste pit, and in a manner that will prevent leaching into the underlying soil or onto surrounding areas. Let concrete harden and dispose of as garbage.
- ☐ When washing exposed aggregate, prevent washwater from entering storm drains. Block any inlets and vacuum gutters, hose washwater onto dirt areas, or drain onto a bermed surface to be pumped and disposed of properly.

# Landscaping

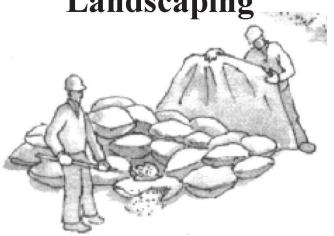

- ☐ Protect stockpiled landscaping materials from wind and rain by storing them under tarps all year-round.
- ☐ Stack bagged material on pallets and under cover.
- ☐ Discontinue application of any erodible landscape material within 2 days before a forecast rain event or during wet weather.

### **Painting & Paint Removal**

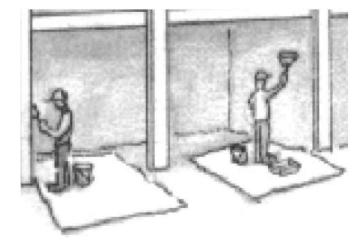


### **Painting Cleanup and Removal**

- ☐ Never clean brushes or rinse paint containers into a street, gutter, storm drain, or stream.
- ☐ For water-based paints, paint out brushes to the extent possible, and rinse into a drain that goes to the sanitary sewer.

  Never pour paint down a storm drain.
- ☐ For oil-based paints, paint out brushes to the extent possible and clean with thinner or solvent in a proper container. Filter and reuse thinners and solvents. Dispose of excess liquids as hazardous waste.
- ☐ Paint chips and dust from non-hazardous dry stripping and sand blasting may be swept up or collected in plastic drop cloths and disposed of as trash.
- ☐ Chemical paint stripping residue and chips and dust from marine paints or paints containing lead, mercury, or tributyltin must be disposed of as hazardous waste.

  Lead based paint removal requires a statecertified contractor.

### **Dewatering**

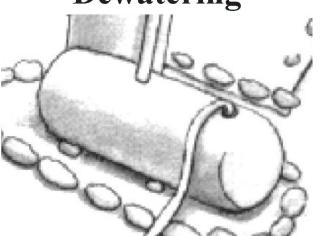

- Discharges of groundwater or captured runoff from dewatering operations must be properly managed and disposed. When possible send dewatering discharge to landscaped area or sanitary sewer. If discharging to the sanitary sewer call your local wastewater treatment plant.
- ☐ Divert run-on water from offsite away from all disturbed areas.
- ☐ When dewatering, notify and obtain approval from the local municipality before discharging water to a street gutter or storm drain. Filtration or diversion through a basin, tank, or sediment trap may be required.
- ☐ In areas of known or suspected contamination, call your local agency to determine whether the ground water must be tested. Pumped groundwater may need to be collected and hauled off-site for treatment and proper disposal.

Storm drain polluters may be liable for fines of up to \$10,000 per day!

PROFESSIONAL CHIEF OF CALIFORNIE OF CALIFORNIE OF CALIFORNIE CIVIL

AND ASSOCIATES

GINEERING - LAND SURVEYING

-SAN CARLOS - CA 94070 - (650) 593-89

CENTER STREET.SAN CARLC

SKY 965 CENTE

JEFFARED FOR:

RUCTION BEST MANAG PRACTICES PLAN 08 DEER CREEK LANE

ORAWN BY: AAP

DESIGNED BY: VPG

CHECKED BY: DGM

SCALE: 1"=16'

DATE: 12/15/23

DRAWING NO.

5402-CBMP

**C-4**