COUNTY OF **SAN MATEO**PLANNING AND BUILDING

County Government Center 455 County Center, 2nd Floor Redwood City, CA 94063 650-363-4161 T 650-363-4849 F www.planning.smcgov.org

March 31, 2017

Lin Chuwen 141 Santa Helena Avenue, Apt. #5 San Bruno, CA 94066

Dear Ms. Chuwen:

SUBJECT: Coastside Design Review

Marine Boulevard, Moss Beach

APN 037-186-210; County File No. PLN 2016-00429

At its meeting of February 9, 2017, the San Mateo County Coastside Design Review Committee (CDRC) considered your application for a Design Review Permit allow construction of a new 1,339 sq. ft. two-story single-family residence, plus a 485 sq. ft. attached two-car garage, on an existing 3,800 sq. ft., non-conforming legal parcel (Certificate of Compliance recorded on June 24, 2015), as part of a staff-level Coastal Development Permit (CDP). No trees are proposed for removal. The CDP is not appealable to the California Coastal Commission.

The CDRC was unable to make the findings for design review approval based on certain design deficiencies. In order to resolve these deficiencies in the project's design, a more thorough review of the "Standards for Design for One-Family and Two-Family Residential Development in the Midcoast" manual is required, specifically on Section 6565.20(D) and Section 6565.20(F). As such, requirements and recommendations from the CDRC for further project redesign are as follows:

Requirements:

- 1. Section 6565.20(F)1. LANDSCAPING, PAVED AREAS, FENCES, LIGHTING AND NOISE. Submit a detailed landscape plan to include drought tolerant as well as native or non-invasive trees, shrubs and/or groundcover. Install landscaping in proposed mulched areas to enhance property appearance.
- 2. Section (6565.20(F)2. LANDSCAPING, PAVED AREAS, FENCES, LIGHTING AND NOISE. Submit and indicate on revised plans manufacturer's specification sheets for all exterior lighting and material details for all paved areas.
- 3. Section 6565.20(F)4). LANDSCAPING, PAVED AREAS, FENCES, LIGHTING AND NOISE. Indicate on revised floor plans and elevations, the location of all "Dark Sky" compliant, downward directed exterior lighting fixtures.



- 4. Section 6565.20(D)3. ELEMENTS OF DESIGN. The roof feature should either redesigned to include dormers to enhance the articulation and functional aspects of the roof lines.
- 5. Section 6565.20(D)1.e. ELEMENTS OF DESIGN. The side and back wall facades are flat with little architectural detail. Introduce 'offset' wall planes to help reduce the boxy appearance prevalent on three sides and enhance the visual interest to match the front elevation.
- 6. Section 6565.20(D)2.b. ELEMENTS OF DESIGN. All windows and doors should be of consistent style.

Recommendations:

- 1. Section 6464.20(D)1.e. ELEMENTS OF DESIGN. Add another color to enhance visual interest on the sides and back facades of the residence.
- 2. Instead of its current garage access location, relocate or enclose the main staircase of the residence.

At the meeting, you were presented with the following available options at the end of the CDRC's deliberation of the project: (i) request for a decision from the CDRC on the plans presented or (ii) request that the project be considered at the next meeting to provide you with ample time to consider and incorporate the elements recommended for project redesign. You chose the second option, and the CDRC directed staff to schedule your project for consideration at a later date.

Please contact Dennis P. Aguirre, Design Review Officer, at 650/363-1867, if you have any questions.

To provide feedback, please visit the Department's Customer Survey at the following link: http://planning.smcgov.org/survey.

Sincere

Dennis P-Aguirre Design Review Office

DPA:pac - DPABB0140 WPN.DOCX

cc: Dianne Whitaker, Member Architect
Stuart Grunow, Member Architect
Beverly Garrity, Montara Community Representative





Lin-Jiang Residence ⁰ Marine Boulevard , Moss Beach CA

Three Dimensional Views Sheet 2 of 2



Project Name	Date

Type or Model_____

Model #

Prepared By


VOLT® Low Voltage Landscape Lighting Deck Light - 600 Series

Product Description

The Deck Light is a high quality low voltage outdoor lighting deck fixture from VOLT. Featuring easy access faceplate, no tools are required. Rotate the faceplate into a lock positon onto an o-ring gasket. Sealed solid brass fixture means it's perfect for post lighting on piers or docks as well as decking and other hardscaping. Professional quality internal components make for a fixture that will last a long time, even through hash outdoor elements.



Product Dimensions

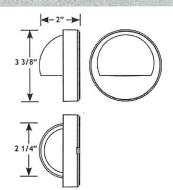

Features & Benefits

- Solid Brass Construction.
- Pre-aged finish; with a natural patina that does not corrode, or the option for a white powder coating.
- Deramic white interior reflects light to maximize output and beam spread.
- Beryllium copper socket more corrosion resistant than
- ▶ Silicone plug at lead wire exit prevents ground moisture and insects from entering luminaire through the stem.
- Machine threaded body screws tight onto an O-ring for a moisture tight design. MAT

San Mateo County Planning and Building Department

Specifications

- D Construction: Cast Brass
- Finish: Bronze or white Powder Coat
- Lead Wire: 48" (standard) or 25' (optional) 16AWG, SPT-2 premium tinned copper
- Mounting: Two Lock Screws
- Glass or Lens: Frosted Glass
- ▶ Light Source (not included): Bipin (LED or Halogen)
- Maximum Lamp Rating: 20W
- Doperating Voltage: 12V AC
- Shipping Weight: 1 lb
- Powered by: VOLT's Low Voltage Transformer

Warranty

Lifetime Warranty

Certifications



LISTED File #E466348 1 9 - 4 1 4 2 9

PRODUCT SPECIFICATIONS



VOLT® Low Voltage Landscape Lighting Deck Light - 600 Series

Lamp Options

Item Number	Description	Power Supply Requirement
G4-15-12v-827	VOLT® 15 watt equivalent LED bi-pin 2700K	2W
G4-15-12v-830	VOLT® 15 watt equivalent LED bi-pin 3000K	2W
8JC10-10W	10W BiPin Halogen Lamp	10W
8JC10-20W	20W BiPin Halogen Lamp	20W

Lamp Specs

15 watt Equivalent

25 Lumens

Ordering Information	Example: 0	Order # 600-48-B
600	-48	-BR
Product Family	Wire Length	
600 = Deck Light	48 = 48" 25 = 25'	BR= Bronze WH= White



VOLT® Low Voltage Landscape Lighting Max Spread, Path & Area Lights - 330 Series

Lamp Options

Item Number	Description	Power Supply Requirement
G4-15-12V-827	VOLT® 15 watt equivalent LED Bi-Pin 2700K	2W
G4-20-12V-827	VOLT® 20 watt equivalent LED Bi-Pin 2700K	3W
G4-35-12V-827	VOLT® 35 watt equivalent LED Bi-Pin 2700K	4W
G4-15-12V-830	VOLT® 15 watt equivalent LED Bi-Pin 3000K	2W
G4-20-12V-830	VOLT® 20 watt equivalent LED Bi-Pin 3000K	3W
G4-35-12V-830	VOLT® 35 watt equivalent LED Bi-Pin 3000K	4W
8JC10-10W	10W Bi-Pin Halogen Lamp	10W
8JC10-20W	20W Bi-Pin Halogen Lamp	20W

Lamp Specs

15 watt Equivalent	20 watt Equivalent	35 Watt Equivalent
115 Lumens	185 Lumens	265 Lumens

Accessories

Item Number	Description	
9C-AB	VOLT's Hammer Stake with Solid Brass Top Cover	
9SM-AB	Surface Mount - Brass with Bronze Finish	
9TRIDENT8	8" Brass Trident Stake with Bronze Finish	
9BRASSSTAKE	Brass Stake	
9HAMMERSTAKE13	13" XL Hammer Stake	
9R-BRASS-RISER-P-1	Solid Brass Extension Pole 6"	
9R-BRASS-RISER-P-2	Solid Brass Extension Pole 12"	
9R-BRASS-RISER-P-3	Solid Brass Extension Pole 24"	
9R-COPPER-RISER-P-1	Solid Copper Extension Pole 6"	
9R-COPPER-RISER-P-2	Solid Copper Extension Pole 12"	
9R-COPPER-RISER-P-3	Solid Copper Extension Pole 24"	

Ordering Information	Example: (Order # 330C-48
330		-48
Product Family	Construction	Wire Length
330 = Max Spread	blank = Brass "C" = Copper	48 = 48" 25 = 25'

Specifications subject to change without notice.
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NPDES NOTES

TACKING, OR WIND.

NOTES MUST BE SHOWN AS WORDED, ON THE TITLE SHEET OF THE PLAN. 1. IN THE CASE OF EMERGENCY, CALL

AT WORK PHONE # OR CELL PHONE #

2. SEDIMENT FROM AREAS DISTURBED BY CONSTRUCTION SHALL BE RETAINED ON SITE USING STRUCTURAL CONTROLS TO THE MAXIMUM EXTENT PRACTICABLE. 3. STOCKPILES OF SOIL SHALL BE PROPERLY CONTAINED TO MINIMIZE SEDIMENT TRANSPORT FROM THE SITE TO STREETS, DRAINAGE FACILITIES OR ADJACENT PROPERTIES VIA RUNOFF, VEHICLE

4. APPROPRIATE BMPS FOR CONSTRUCTION - RELATED MATERIALS, WASTES, SPILLS SHALL BE IMPLEMENTED TO MINIMIZE TRANSPORT FROM THE SITE TO STREETS, DRAINAGE FACILITIES, OR ADJOINING PROPERTIES BY WIND OR RUNOFF.

5. RUNOFF FROM EQUIPMENT AND VEHICLE WASHING SHALL BE CONTAINED AT CONSTRUCTION SITES UNLESS TREATED TO REDUCE OR REMOVE SEDIMENT AND OTHER POLLUTANTS. 6. ALL CONSTRUCTION CONTRACTOR AND SUBCONTRACTOR PERSONNEL ARE TO BE MADE AWARE OR THE REQUIRED BEST MANAGEMENT PRACTICES AND GOOD HOUSEKEEPING MEASURES FOR THE PROJECT SITE AND ANY ASSOCIATED CONSTRUCTION STAGING AREAS. 7. AT THE END OF EACH DAY OF CONSTRUCTION ACTIVITY ALL CONSTRUCTION DEBRIS AND WASTE

MATERIALS SHALL BE COLLECTED AND PROPERLY DISPOSED IN TRASH OR RECYCLE BINS. 8. CONSTRUCTION SITES SHALL BE MAINTAINED IN SUCH A CONDITION THAT AN ANTICIPATED STORM DOES NOT CARRY WASTES OR POLLUTANTS OFF THE SITE. DISCHARGES OF MATERIAL OTHER THAN STORM WATER ONLY WHEN NECESSARY FOR PERFORMANCE AND COMPLETION OF CONSTRUCTION PRACTICES AND WHERE THEY DO NOT: CAUSE OR CONTRIBUTE TO A VIOLATION OF ANY WATER QUALITY STANDARD: CAUSE OR THREATEN TO CAUSE POLLUTION, CONTAMINATION, OR NUISANCE; OR CONTAIN A HAZARDOUS SUBSTANCE IN A QUANTITY REPORTABLE UNDER FEDERAL REGULATIONS 40 CFR PARTS 117 AND 302. 9. POTENTIAL POLLUTANTS INCLUDE BUT ARE NOT LIMITED TO: SOLID OR LIQUID CHEMICAL SPILLS;

PRESERVATIVES AND SOLVENTS; ASBESTOS FIBERS, PAINT FLAKES OR STUCCO FRAGMENTS; FUELS, OILS, LUBRICANTS, AND HYDRAULIC, RADIATOR OR BATTERY FLUIDS; FERTILIZERS, VEHICLE/EQUIPMENT WASH WATER AND CONCRETE WASH WATER; CONCRETE, DETERGENT OR FLOATABLE WASTES; WASTES FROM ANY ENGINE/EQUIPMENT STEAM CLEANING OR CHEMICAL DEGREASING AND SUPER - CHLORINATED POTABLE WATER LINE FLUSHING. DURING CONSTRUCTION, PERMITTEE SHALL DISPOSE OF SUCH MATERIALS IN A SPECIFIED AND CONTROLLED TEMPORARY AREA ON — SITE, PHYSICALLY SEPARATED FROM POTENTIAL STORM WATER RUNOFF, WITH ULTIMATE DISPOSAL IN ACCORDANCE WITH LOCAL, STATE AND FEDERAL REQUIREMENTS.

WASTES FROM PAINTS, STAINS, SEALANTS, GLUES, LIMES, PESTICIDES, HERBICIDES, WOOD

10. DE - WATERING OF CONTAMINATED GROUNDWATER, OR DISCHARGING CONTAMINATED SOILS VIA SURFACE EROSION IS PROHIBITED. DE — WATERING OF NON — CONTAMINATED GROUNDWATER REQUIRES A NATIONAL POLLUTANT DISCHARGE ELIMINATION SYSTEM PERMIT FROM THE RESPECTIVE STATE REGIONAL WATER QUALITY CONTROL BOARD.

ABBREVIATIONS

A.C.P

A.F.S

ALT.

ALU

ARCH

BLW.

BLDG.

BLCK.

CLG.

CLR.

COL.

CONC.

CONT.

CPT.

C.T.

D.F.

D.S.

DN.

DIM

DTL(S)

ELEC.

ELEV.

EQUIP

E.W.C

EXT.

H.M.

HORZ.

HVAC.

INSUL

DWG(S).

CTR.

Air Conditioning

Above Finish Floor

Above Finish Slab

Alternate

Aluminum

Board

Building

Blocking

Ceiling Joist

Control Joint

Center Line

Ceiling

Column

Concrete

Carpet

Center

Continuous

Ceramic Tile

Disabled Access

Diameter

Downspout

Dimension

Existing

Electrical

Elevator

Exterior

Equipment

Forced Air Unit

Fire Extinguisher

Fire Extinguisher

Face of Concrete

Face of Masonry

Finish Floor

Face of Finish

Face of Stud

Furring

Fire-Retardant

Gauge or Gage

Galvanized Iron

General Contractor

Gypsum Wall Board

GWB Moisture Resistant

Heating, Ventillation, and

GWB Fire Rated "X"

Galvanized

Hollow Core

Hollow Metal

Air-conditioning

Inside Diameter

Horizontal

Hardware

Height

Insulation

Interior

Finish Slab

Floor Drain

Foundation

Electric Water Cooler

Elevation

Expansion Joint

Fach

Detail

Drinking Fountain

Clear

Architect(ural)

Asphaltic Concrete Paving

JAN.

LAM.

MECH.

MEMB.

M.F.

MFR.

MIN.

MTL.

MOM

NTS

O.C.

OCC.

O.D.

OPNG.

O.F.C.I

PLYWD.

PLAST

P.T.

Q.T.

REF

REINF.

R.O.

Rm.

S.A.C.

SPEC.

S.STL.

SUSP.

SHT.

T.O.B.

T.O.C.

T.O.S.

T.O.SL.

T.O.W.

T.P.

TYP.

THK.

U.N.O.

V.C.T.

VERT.

V.W.C.

W.I.C.

WIN

W.H

W.W.F.

TEMP

STRUCT

STD.

STL.

SQ. FT./SF

S.C.

O.H.

Janitor Joint

Lavatory

Laminate

Maximum

Mechanical

Manufacturer

Manufacturer Finish

Masonry Opening

Not in Contract

Not To Scale

On Center

Occupancy

Overhang

Opening

Opposite

Paint

Pair

Outside Diameter

Owner Furnished

Property Line

Pressure Treated

Quarry Tile

Refer (to)

Required

Reinforend

Solid Core

Square Foot

Specifications

Stainless Steel

Structural (Engineer)

Top of Beam - Steel

Underwriters Laboratory

Unless Noted Otherwise

Vinyl Composition Tile

Vinyl Wall Covering

Verify in Field

Wrought Iron

Water Closet

Water Heater

Water Resistant

Welded Wire Fabric

Walk in Closet

Top of Concrete

Top of Sheathing

Top of Slab

Top of Wall

Top Plate

Tempered

Typical

Vertical

Washer

With

Wood

Window

Thick

Standard

Sheet

Suspended

Rough Opening

Suspended Acoustical Ceiling

Contractor Installed

Membrane

Minimum

Nominal

Over

11. GRADED AREAS ON THE PERMITTED AREA PERIMETER MUST DRAIN AWAY FROM THE FACE OF SLOPES AT THE CONCLUSION OF EACH WORKING DAY. DRAINAGE IS TO BE DIRECTED TOWARD

DE- SILTING FACILITIES. 12. THE PERMITTEE AND CONTRACTOR SHALL BE RESPONSIBLE AND SHALL TAKE NECESSARY PRECAUTIONS TO PREVENT PUBLIC TRESPASS ONTO AREAS WHERE IMPOUNDED WATER CREATES A

13. THE PERMITTEE AND CONTRACTOR SHALL INSPECT THE EROSION CONTROL WORK AND INSURE

THAT THE WORK IS IN ACCORDANCE WITH THE APPROVED PLANS. 14. THE PERMITTEE SHALL NOTIFY ALL GENERAL CONTRACTORS, SUBCONTRACTORS, MATERIAL SUPPLIERS, LESSEES, AND PROPERTY OWNERS: THAT DUMPING OF CHEMICALS INTO THE STORM DRAIN

SYSTEM OR THE WATERSHED IS PROHIBITED. 15. EQUIPMENT AND WORKERS FOR EMERGENCY WORK SHALL BE MADE AVAILABLE AT ALL TIMES DURING THE RAINY SEASON. NECESSARY MATERIALS SHALL BE AVAILABLE ON SITE AND STOCKPILED AT CONVENIENT LOCATIONS TO FACILITATE RAPID CONSTRUCTION OF TEMPORARY DEVICES WHEN RAIN IS IMMINENT.

16. ALL REMOVABLE EROSION PROTECTIVE DEVICES SHALL BE IN PLACE AT THE END OF EACH WORKING DAY WHEN THE 5 - DAY RAIN PROBABILITY FORECAST EXCEEDS 40%. 17. SEDIMENTS FROM AREAS DISTURBED BY CONSTRUCTION SHALL BE RETAINED ON SITE USING AN EFFECTIVE COMBINATION OF EROSION AND SEDIMENT CONTROLS TO THE MAXIMUM EXTENT PRACTICABLE, AND STOCKPILES OF SOIL SHALL BE PROPERLY CONTAINED TO MINIMIZE SEDIMENT TRANSPORT FROM THE SITE TO STREETS, DRAINAGE FACILITIES OR ADJACENT PROPERTIES VIA RUNOFF, VEHICLE TRACKING, OR WIND.

18 APPROPRIATE BMPS FOR CONSTRUCTION - RELATED MATERIALS, WASTES, SPILLS OR RESIDUES SHALL BE IMPLEMENTED AND RETAINED ON SITE TO MINIMIZE TRANSPORT FROM THE SITE TO STREETS. DRAINAGE FACILITIES, OR ADJOINING PROPERTY BY WIND OR RUNOFF.

APPLICABLE CODE:

2013 CALIFORNIA BUILDING CODE


2013 CALIFORNIA ELECTRICAL CODE

2013 CALIFORNIA MECHANICAL CODE


2013 CALIFORNIA PLUMBING CODE

2013 CALIFORNIA GREEN BUILDING CODE 2013 T-24 ENERGY CODE

VICINITY MAP

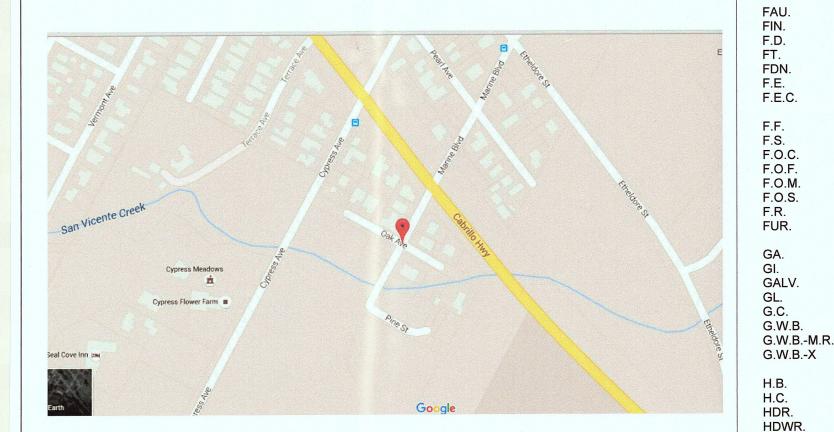

JIANG-LIN RESIDENCE - NEW CONSTRUCTION

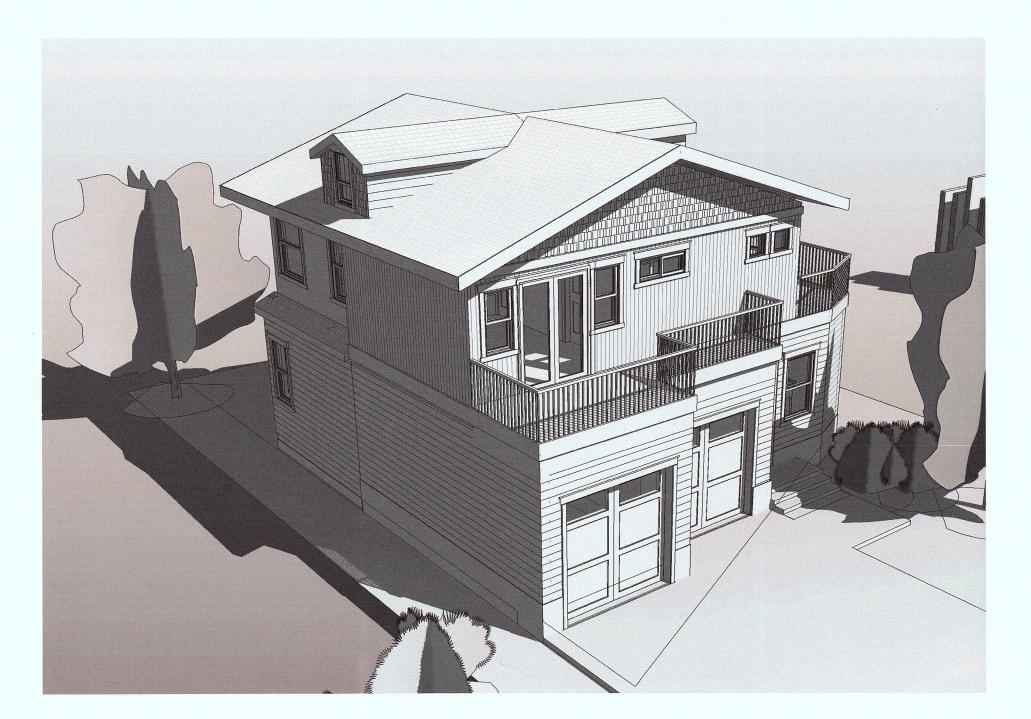

GREEN BUILDING CODE NOTES

1. THE CONSTRUCTION DOCUMENTS SHALL PROVIDE SUFFICIENT CLARIFY TO INDICATE THE LOCATION, NATURE, AND SCOPE OF THE PROPOSED GREEN BUILDING

2. PLUMBING FIXTURES AND FITTINGS SHALL MEET THE STANDARDS REFERENCED IN CGBC TABLE 4.303.3. CGBC 4303.3

3. SEAL OPENINGS IN THE BUILDING ENVELOPE IN COMPLIANCE WITH THE CALIFORNIA ENERGY CODE (CEC). AMMLAR SPACES AROUND PIPES, ELECTRIC CABLES, CONDUITS OR OTHER OPENINGS IN PLATES AT EXTERIOR WALLS SHALL BE PROTECTED BY CLOSING SUCH OPENINGS WITH CEMENT MORTAR, CONCRETE MASONRY. OR A SIMILAR METHOD ACCEPTABLE TO THE ENFORCING AGENCY. CGBC 4.406.1

4. REDUCE CONSTRUCTION WASTE BY RECYCLING OR SALVAGING FOR RE-USE A MMLMUM OF 50 PERCENT OF THE NONHAZARDOUS CONSTRUCTION AND DEMOLITION DEBRIS, OR MEET THE LOCAL CONSTRUCTION AND DEMOLITION WASTE MANAGEMENT ORDINANCE, WHICHEVER IS MORE STRINGENT. CGBC 4.408.1

RECYCLING, REUSE ON THE PROJECT OR SALVAGE FOR FUTURE USE OR

5. CONSTRUCTION WASTE MANAGEMENT PLAN AND DOCUMENTATION DEMONSTRATING COMPLIANCE WITH THE PLAN SHALL BE SUBMITTED THAT:

B. SPECIFIES IF MATERIALS WILL BE SORTED ON-SITE OR MIXED FOR TRANSPORTATION TO A DIVERSION FACILITY.

C. IDENTIFIES THE DIVERSION FACILITY WHERE THE MATERIAL COLLECTION WILL BE TAKEN.

A. IDENTIFIES THE MATERIALS TO BE DIVERTED FROM DISPOSAL BY

D. IDENTIFIES CONSTRUCTION METHODS EMPLOYED TO REDUCE THE AMOUNT OF WASTE GENERATED. E. SPECIFIES THAT THE AMOUNT OF MATERIALS

6. AN OPERATION AND MAINTENANCE MANUAL WITH CONTENT PER CGBC 4.410.1 AND IN A FORMAT ACCEPTABLE TO THE ENFORCING AGENCY SHALL BE PLACED IN THE BUILDING AT THE TIME OF FINAL INSPECTION. CGBC 4.410.1. REFER TO HCD RESIDENTIAL GUIDE FOR MANUAL FORMAT AND SUGGESTED CONTENT.

7.GAS FIREPLACES TO BE DIRECT-VENT SEALED-COMBUSTION TYPE. WOODSTOVES OR PELLET STOVES SHALL COMPLY WITH U.S. EPA PHASE II EMISSION LIMITS. CGBC

8. ALL DUCT OPENINGS AND OTHER AIR DISTRIBUTION COMPONENT OPENINGS SHALL BE PROTECTED DURING STORAGE ON THE CONSTRUCTION SITE UNTIL FINAL START-UP WITH TAPE, PLASTIC, SHEET METAL, OR OTHER ACCEPTABLE METHODS TO REDUCE THE AMOUNT OF DUST AND DEBRIS WHICH MAY COLLECT IN THE SYSTEM. CGBC 4.504.1 9. FINISH MATERIALS SHALL COMPLY WITH CGBC 4.504.2.

10. ADHESIVES, ADHESIVE BONDING PRIMERS, ADHESIVE PRIMERS, SEALANTS, SEALANT PRIMERS, AND CAULKS SHALL COMPLY WITH LOCAL OR REGIONAL AIR POLLUTION CONTROL OR AIR QUALITY MANAGEMENT DISTRICT RULES WHERE APPLICABLE. OR MEET THE REQUIREMENT OF SCAQMD RULE 1168 VOC LIMITS AND PROHIBITION ON THE USE OF CERTAIN TOXIC CHEMICALS, EXCEPT PER SUBSECTION 2. CGBC 4.504.2.1, SUBSECTION 1

11. AEROSOL ADHESIVES, SMALLER UNIT SIZES OF ADHESIVES, AND SEALANT OR CAULKING COMPOUNDS (IN UNITS OF PRODUCT, LESS PACKING, WHICH DO NOT WEIGH MORE THAN 1 POUND AND DO NOT CONSIST OF MORE THAN 16 FLUID OLMCES SHALL COMPLY WITH STATEWIDE VOC STANDARDS AND OTHER REQUIREMENTS, INCLUDING PROHIBITIONS ON THE USE OF CERTAIN TOXIC COMPOUNDS, OF CCR, TITLE 17, COMMENCING WITH SECTION 94507. 4 CGBC.504.2.1, SUBSECTION 2

12. VOC CONTENT LIMITS FOR ARCHITECTURAL COATINGS (ARCHITECTURAL PAINTS) SHALL COMPLY WITH CGBC TABLE 4.504.3.

13. AEROSOL PAINTS AND COATINGS SHALL MEET THE REQUIREMENTS OF SECTIONS 94522(A)(3), 94522(C)(2), AND (D)(2) OF CALIFORNIA CODE OF REGULATIONS, TITLE 17 COMMENCING WITH SECTION 94520. CGBC 4.504.2.3

14. VERIFICATION OF COMPLIANCE WITH FINISH MATERIALS SHALL BE PROVIDED AT THE REQUEST OF THE ENFORCING AGENCY. DOCUMENTS MAY INCLUDE, BUT NOT

A. MANUFACTURER'S PRODUCT SPECIFICATION.

B. FIELD VERIFICATION OF ON-SITE PRODUCT CONTAINERS. C. OTHER METHODS APPROVED BY THE LOCAL JURISDICTION.

15. CARPETS SHALL MEET ONE OF THE FOLLOWING: 1. CARPET AND RUG INSTITUTE'S GREEN LABEL PLUS PROGRAM, 2. CALIFORNIA DEPARTMENT OF PUBLIC HEALTH STANDARD PRACTICE FOR THE TESTING OFVOCS (SPECIFICATION 01350), 3. NSF/ANSI 140 AT THE GOLD LEVEL. 4. SCIENTIFIC CERTIFICATIONS SYSTEMS INDOOR

16. CARPET CUSHION SHALL MEET THE REQUIREMENTS OF THE CARPET AND RUG INSTITUTE GREEN LABEL PROGRAM, CARPET ADHESIVE SHALL MEET THE REQUIREMENTS OF CGBC TABLE 4.504.1. CGBC 4.504.3.1, 4.504.3.2

17. FOR RESILIENT FLOORING, AT LEAST 50 PERCENT OF THE FLOOR AREA SHALL COMPLY WITH VOC EMISSION LIMITS DEFINED IN THE COLLABORATIVE FOR HIGH PERFORMANCE SCHOOLS (CI-IPS) LOW-EMITTING MATERIALS LIST OR CERTIFIED UNDER THE RESILIENT FLOOR COVERING INSTITUTE (RFCI) FLOORSCORE PROGRAM.

18. HARDWOOD PLYWOOD, PARTICLEBOARD, AND MEDIUM DENSITY FIBERBOARD COMPOSITE WOOD PRODUCTS SHALL MEET THE REQUIREMENTS FOR FORMALDEHYDE LIMITS IN CGBC TABLE 4.504.5. CGBC 4.504.5

19. DOCUMENTATION SHALL BE PROVIDED TO INDICATE COMPLIANCE WITH CGBC 4.504 AND SHALL INCLUDE AT LEAST ONE OF THE FOLLOWING: PRODUCT CERTIFICATIONS AND SPECIFICATIONS, CHAIN OF CUSTODY CERTIFICATIONS, OR OTHER METHODS ACCEPTABLE TO THE ENFORCING AGENCY. CGBC 4.504.5.1

20. CONCRETE SLAB FOUNDATIONS REQUIRED TO HAVE A VAPOR RETARDER BY CBC, CCR TITLE 24, PART 2, CHAPTER 19 SHALL ALSO COMPLY WITH THIS SECTION. PROVIDE A CAPILLARY BREAK INSTALLED IN. COMPLIANCE WITH ONE OF THE FOLLOWING:

A. A 4-INCH THICK BASE OF 1/2-INCH OR LARGER CLEAN AGGREGATE, WITH A VAPOR BARRIER IN DIRECT CONTACT WITH CONCRETE, AND A CONCRETE

B. OTHER EQUIVALENT METHODS APPROVED BY THE ENFORCING AGENCY 4.505.2.1 C. A SLAB DESIGN SPECIFIED BY A LICENSED DESIGN PROFESSIONAL. CGBC D. REFERENCE ACI 302.

DESIGN WHICH WILL ADDRESS BLEEDING, SHRINKAGE, AND CURLING.

21. ADD A NOTE TO PLANS THE BUILDING MATERIALS WITB VISIBLE SIGNS OF WATER DAMAGE SHALL NOT BE INSTALLED. CGBC 4.505.3

24. COVERS FOR WHOLE HOUSE EXHAUST FANS SHALL HAVE A MINIMUM INSULATION VALUE OFR-4.2 AND CLOSE WHEN THE FAN IS OFF. CGBC 4.507.

22. MOISTURE CONTENT OF BUILDING MATERIALS, AND VERIFICATION, SHALL MEET THE REQUIREMENTS OF CGBC 4.505.3.

23. BATHROOM EXHAUST FANS SHALL BE ENERGY STAR COMPLIANT, DUCTED TO TERMINATE OUTSIDE THE BUILDING, AND CONTROLLED BY A HUMIDSTAT CAPABLE OF BEING ADJUSTED BETWEEN THE RELATIVE HUMIDITY RANGE OF 50 TO 80 PERCENT. CGBC 4.506

JIANG-LIN

0 MARINE BLVD. MOSS BEACH, CA

MODULAR MANUFACTURES CUTTING EGDE HOME 270 E DOUGLAS AVE. EL CAJON, CA 92020 310-867-3993

	Sheet Name	Sheet Number
?	Titile Sheet	A0
ES	Site Plan	A1
	Floor Plans	A2
	Roof Plan	A3
	Elevations	A4
	Elevations	A4.1
	Building Section	A5
	3D View	A6

Window Schedule

Sheet List

ZONE:

NEW CONSTRUCTION FOR MODULAR HOME

PROJECT DATA:

BUILDING(S) OCCUPANCY: R-1

CONSTRUCT TYPE

STORIES:

- SQUARE FOOTAGE BREAKDOWN		
Name	Area	
PROPOSED FIRST FLOOR	626 SF	
PROPOSED SECOND FLOOR	713 SF	
SITE BUILT DECK	109 SF	
SITE BUILT GARAGE	485 SF	
SITE BUILT PORCH	24 SF	
SITE BUILT DECK	222 SF	
with the second		

R1/S17/DR

PARCEL COVERAGE

1136 (HOUSE + GARAGE) / 3800 (LOT SIZE) X 100 = 30%

PARCEL COVERAGE = BUILDINGS, ACCESSORY BUILDING, OR STRUCTURES SUCH AS PATIOS DECKS, BALCONIES & OTHER SIMILAR OVER 18" ABOVE GROUND

BUILDING FLOOR AREA

HOUSE 1ST FLR (626 SF) + HOUSE 2ND FLR (713 SF)+ SITE BUILT GARAGE (485 SF) =

 $1824 \text{ SF} / 3800 = 0.428 \quad (MAX \ 0.48)$



0 OI! 0 CI

ERMITS AND CONSTRUCTION SHALL BE PROVIDED TO THE OWNER. THESE DOCUMENTS SHALL NOT BE USED FOR ANY PROJECT OTHER THAN THE SPECIFIC PROJECT CONTRACT FOR. NO EXCEPTIONS.

EDGE HOMES ARE AN INSTRUMENT OF SERVICE PROVIDED TO


THE OWNER BY THE DESIGNER THESE DOCUMENTS ARE OWNED BY THE DESIGNER AND COPIES FOR APPROPRIATE

Description PRELIMINARY DESIGN 2015.09.16 REVISED DRAWINGS 2015.10.03 PLANNING SUBMITTAL 2015.12.31 PLANNING CHANGES 2016.05.23 PLANNING CHANGES 2016.12.27

> **LIN & JIANG** RESIDENCE 2 STORY HOME


> > Titile Sheet

15-1715 Project number 2015-09-16 Author Checker Checked by

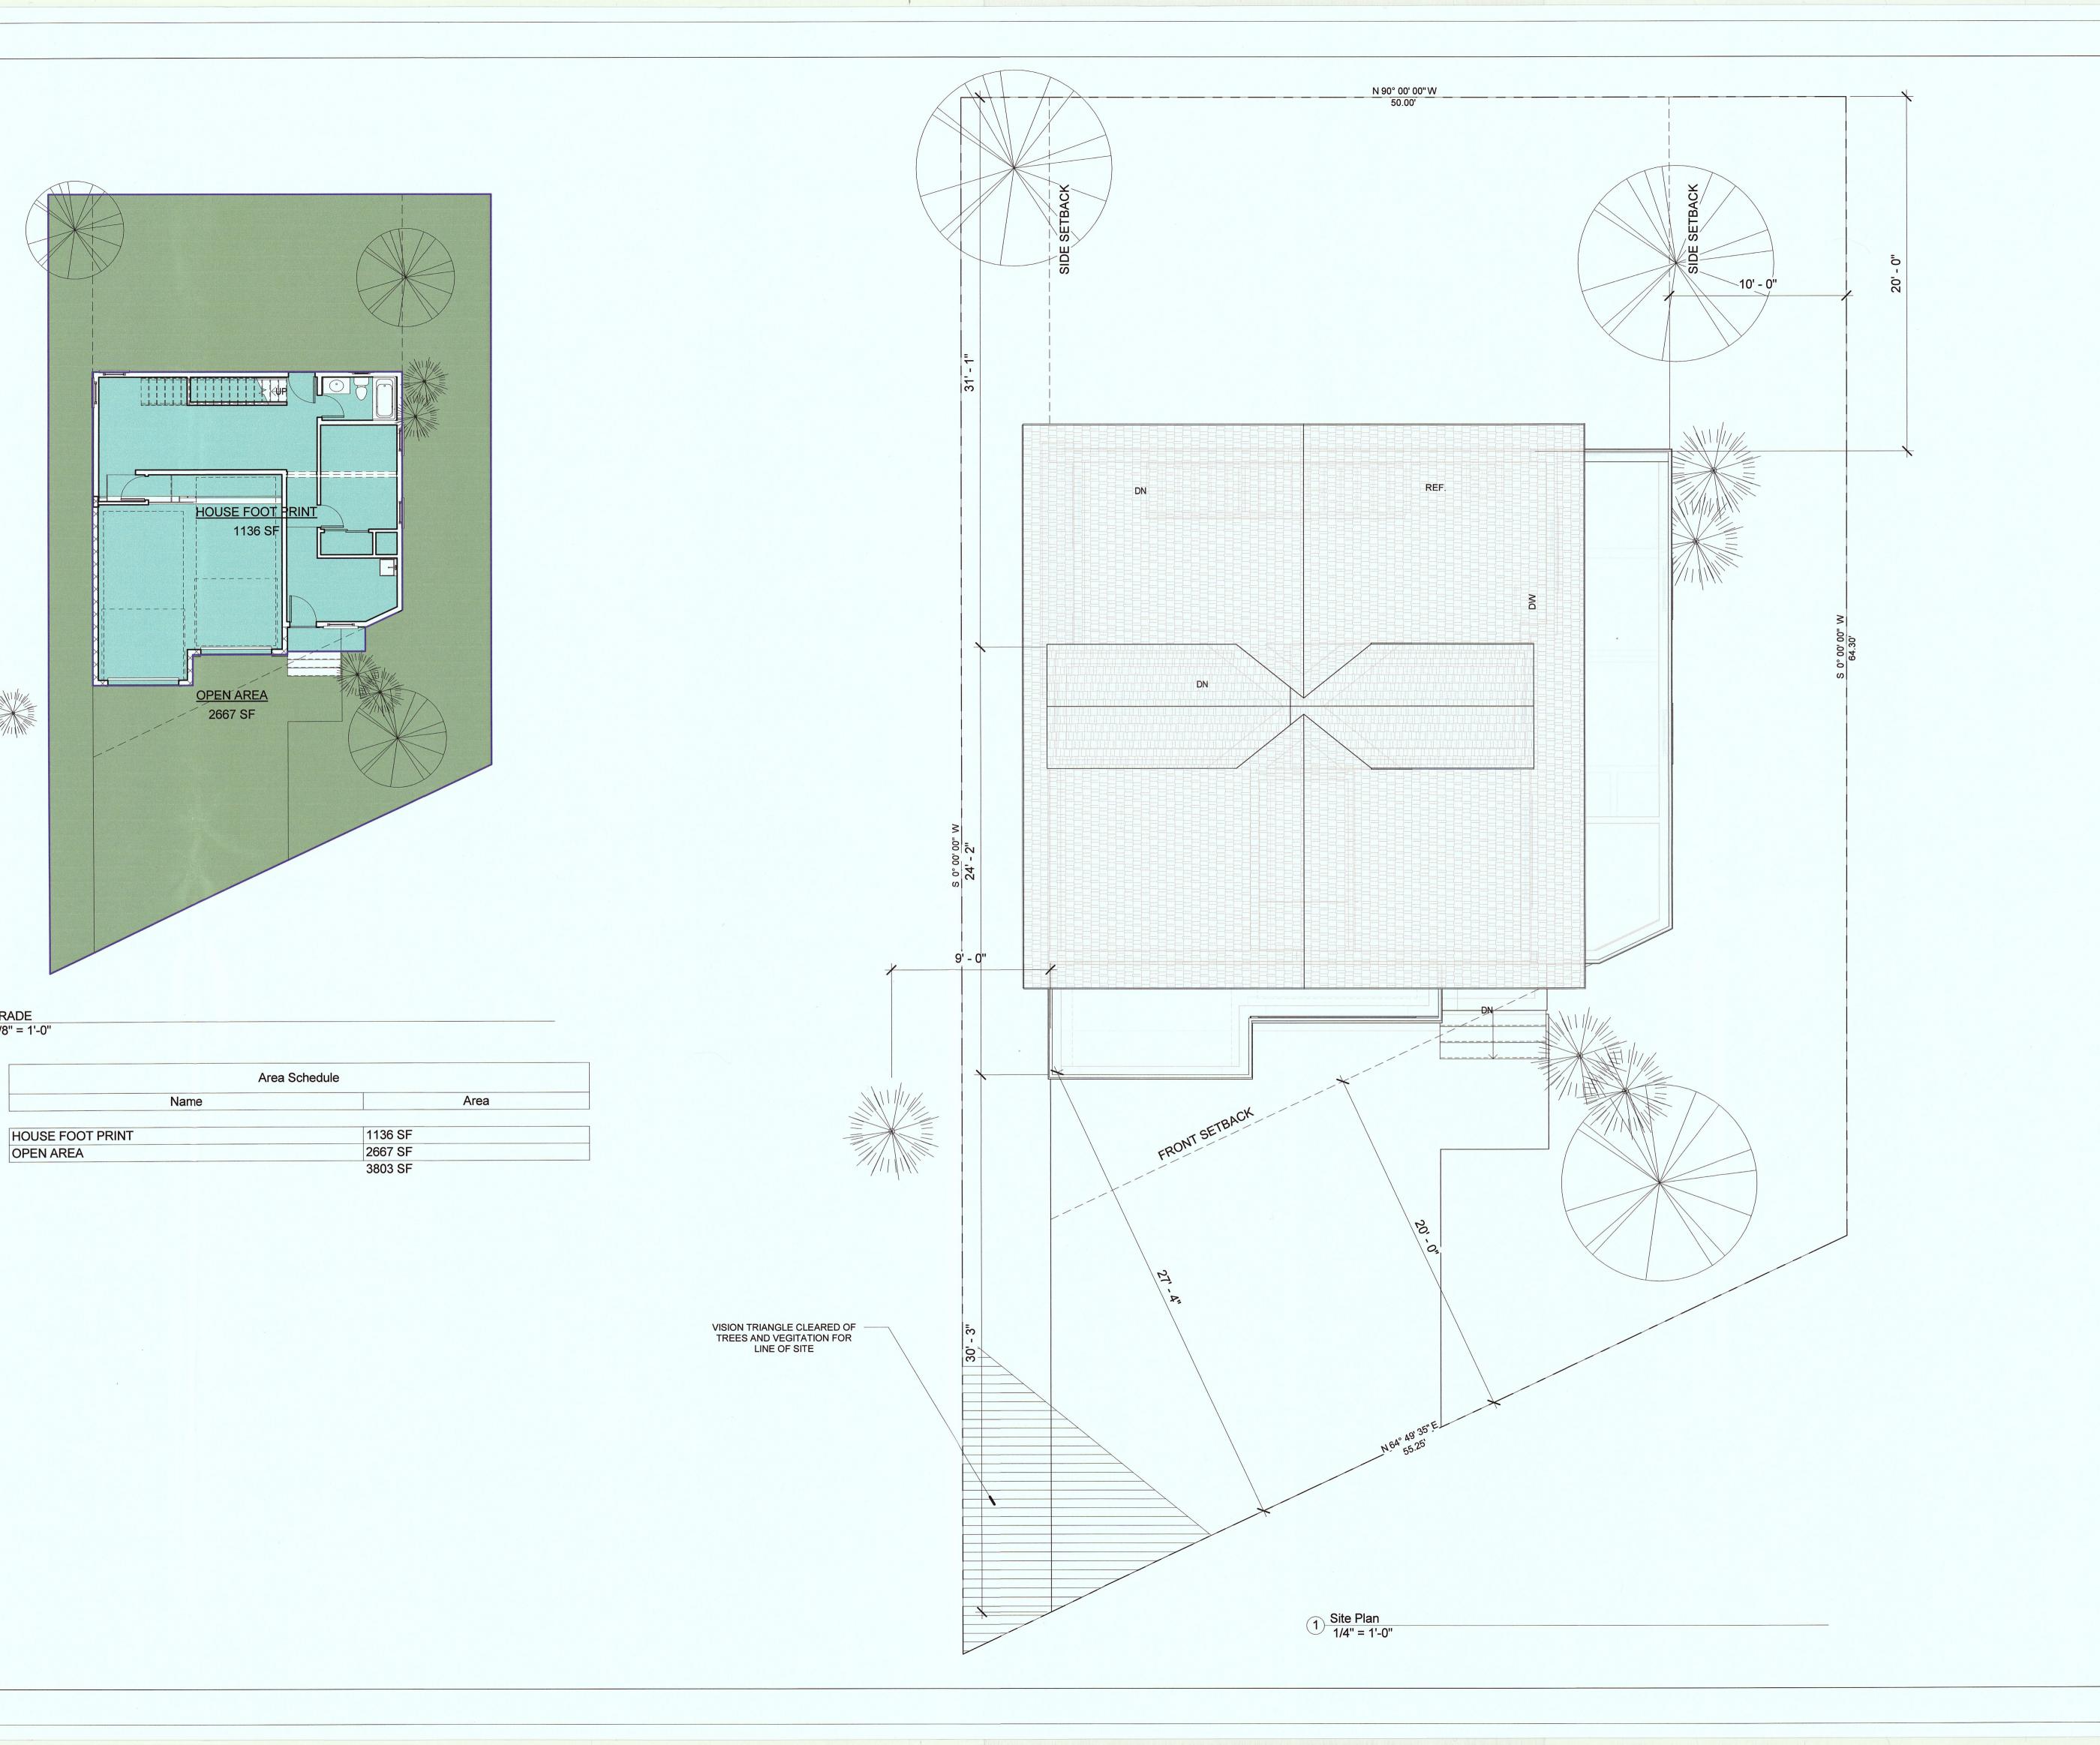

2 GRADE 1/8" = 1'-0"

OPEN AREA

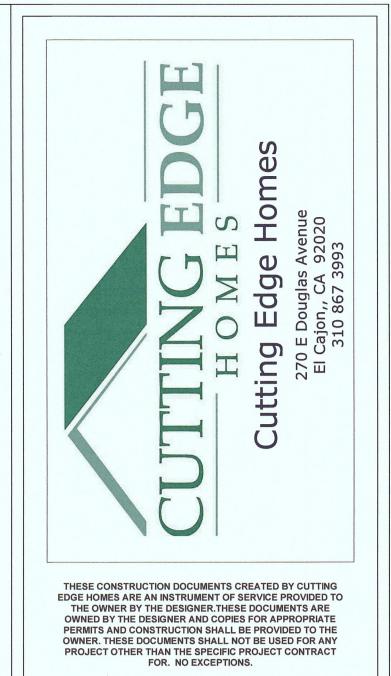

Description Date A PRELIMINARY DESIGN
B REVISED DRAWINGS
C PLANNING SUBMITTAL
D PLANNING CHANGES
E PLANNING CHANGES 2015.09.16 2015.10.03 2015.12.31 2016.05.23 2016.12.27


> LIN & JIANG RESIDENCE 2 STORY HOME


Site Plan

15-1715 Project number 2015-09-16 Date Drawn by Author Checker Checked by **A1**

Scale

As indicated

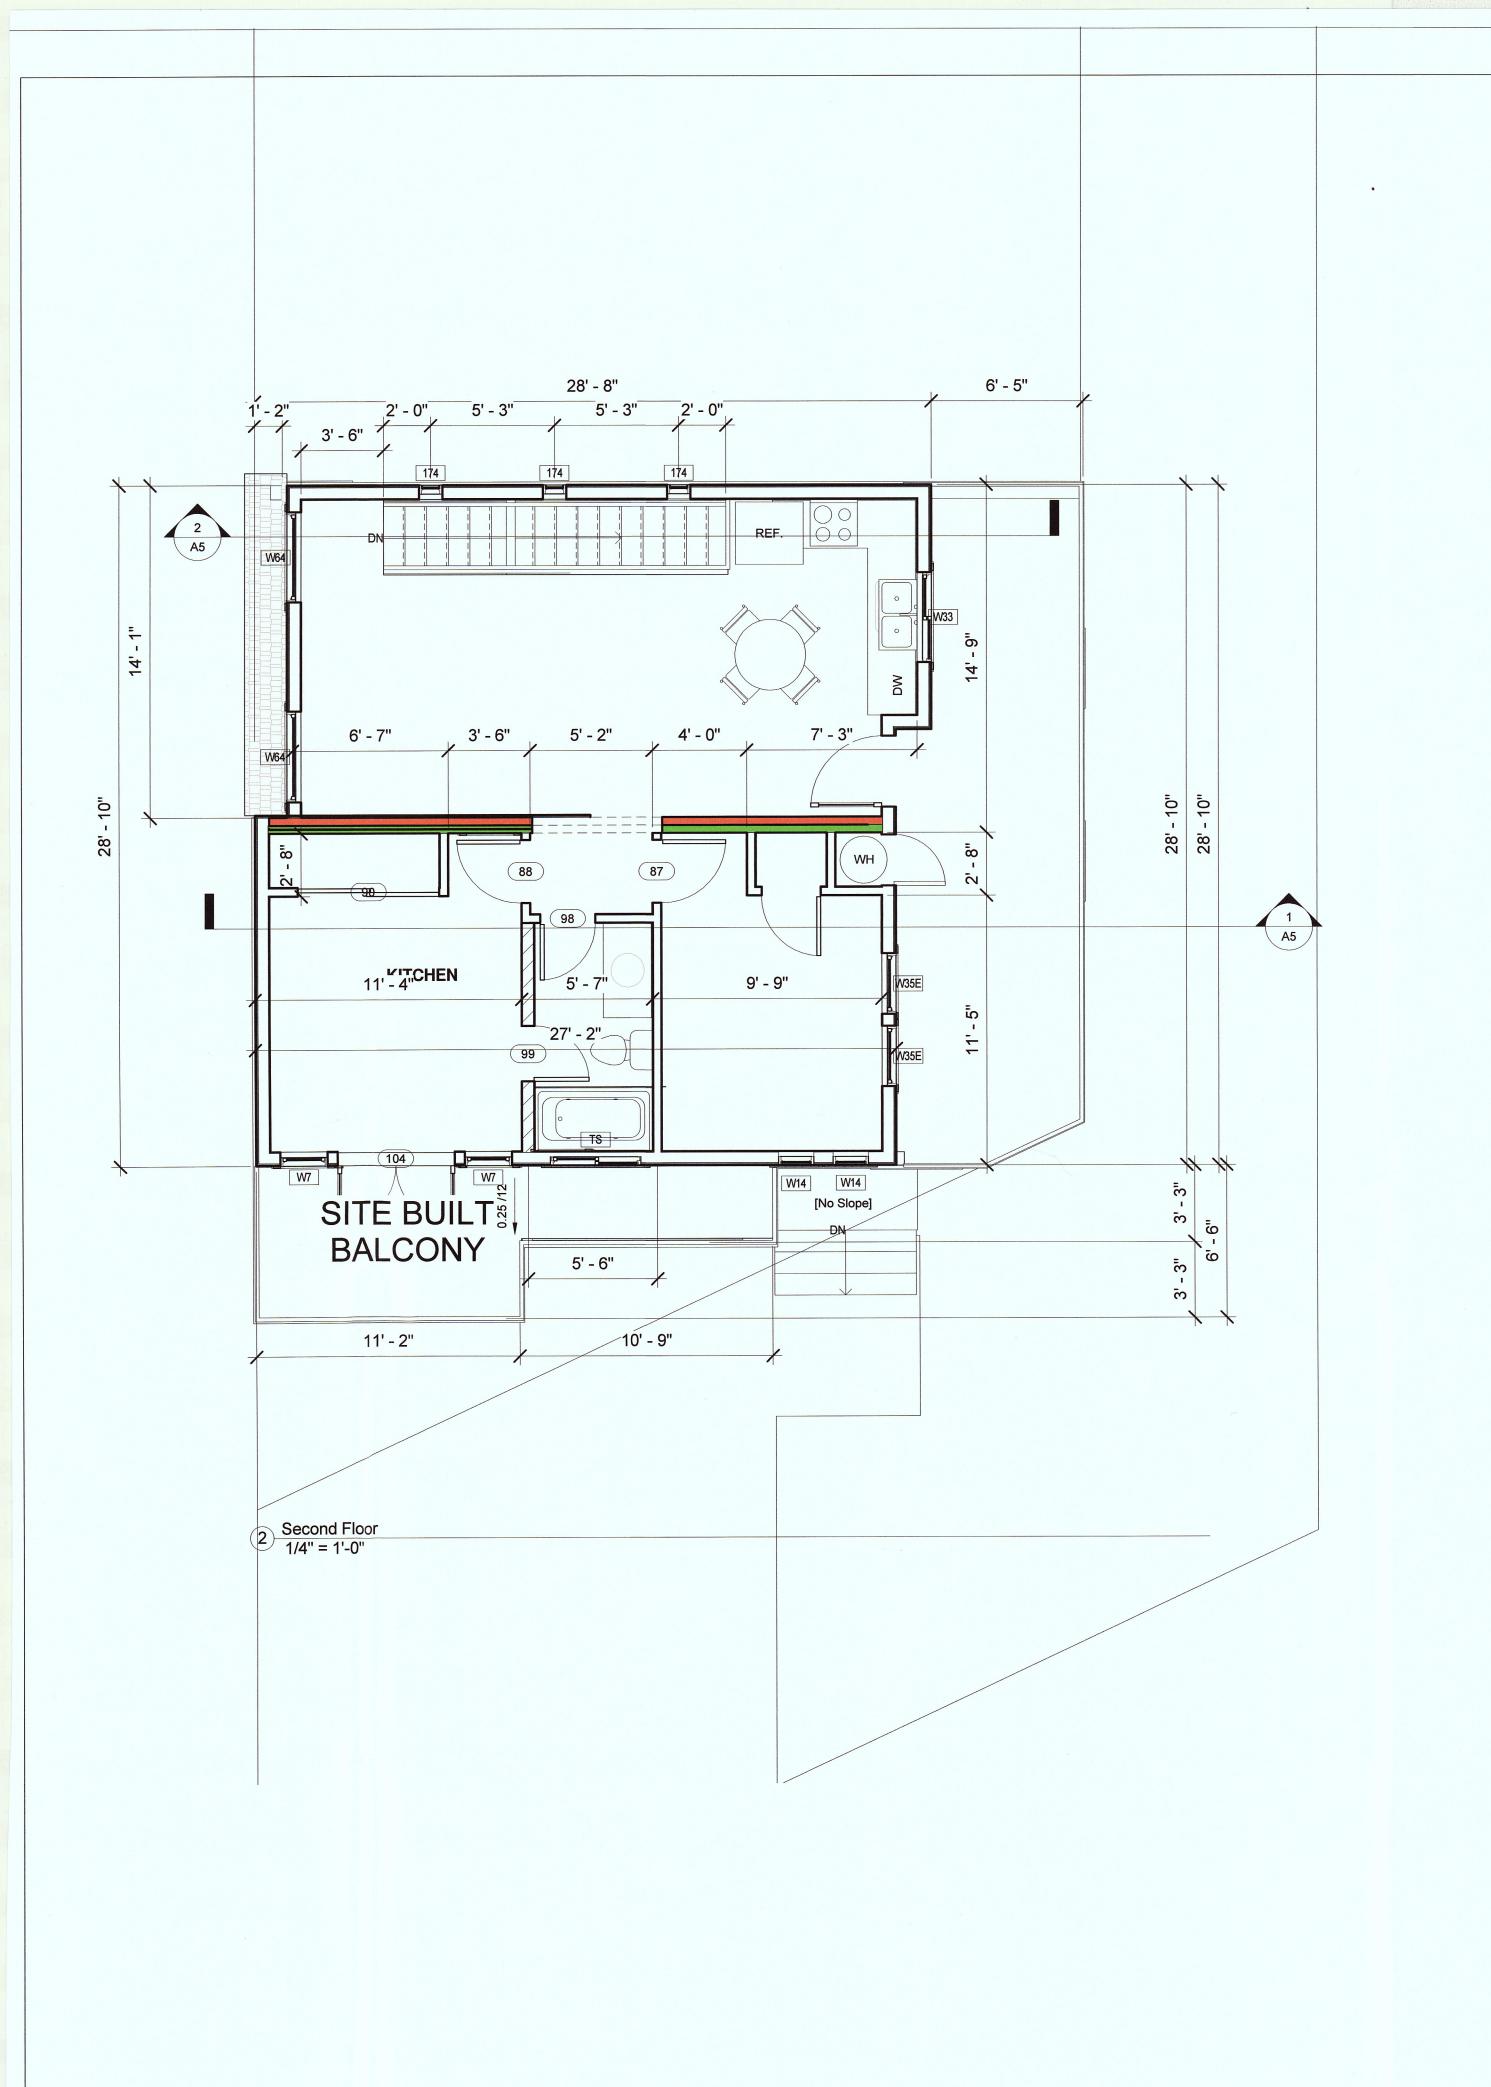

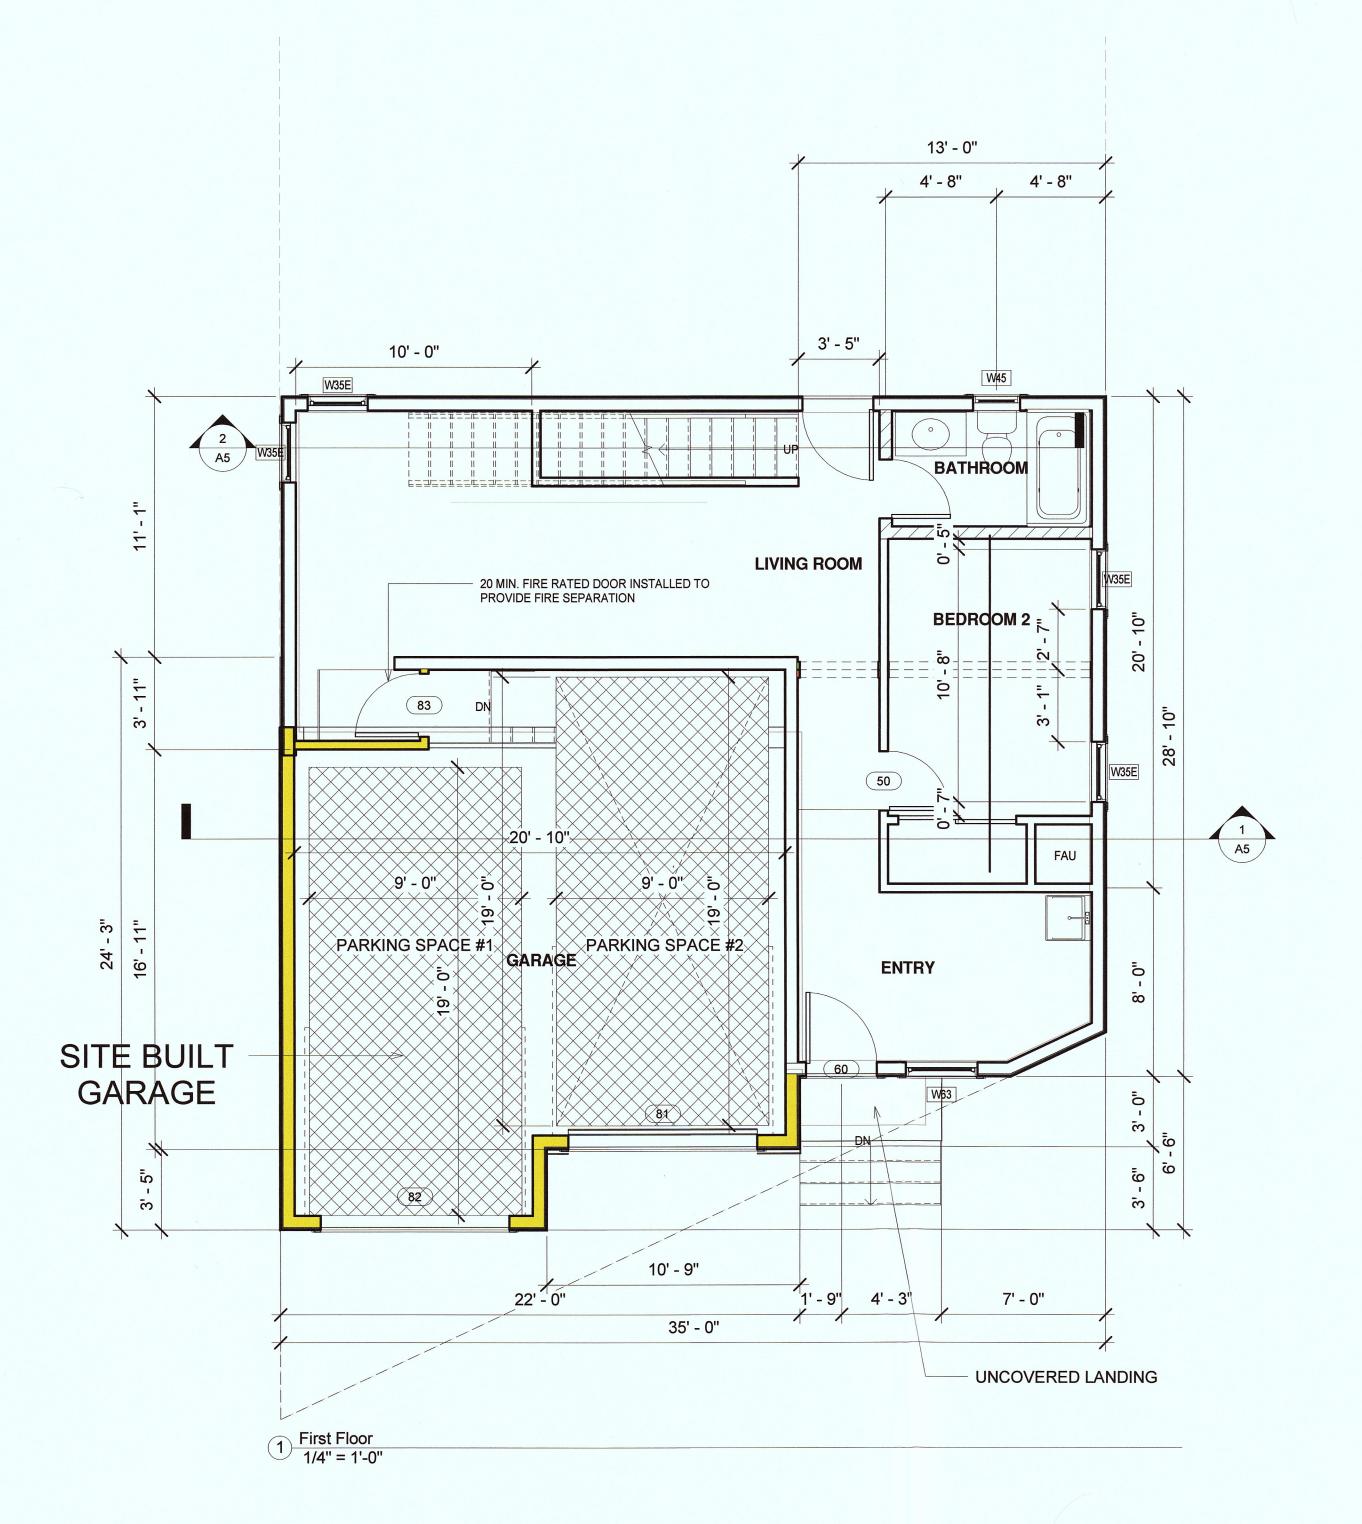

LIN & JIAI RESIDEN O MARINE BL

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No.	Description	Date
Α	PRELIMINARY DESIGN	2015.09.1
В	REVISED DRAWINGS	2015.10.0
С	PLANNING SUBMITTAL	2015.12.3
D	PLANNING CHANGES	2016.05.2
E	PLANNING CHANGES	2016.12.2

LIN & JIANG RESIDENCE 2 STORY HOME

WALL LEGEND

STANDARD 2 X 6 EXTERIOR WALL

INTERIOR 2 X 6 PLUMBING WALL

STRUCTURAL INTERIOR WALL

NON STRUCTURAL INTERIOR WALL

SITE BUILT 2 X 6 WALL

HALF WALL INTERIOR

RAILING


Floor Plans

Project number	15-1715
Date	2015-09-16
Drawn by	Author
Checked by	Checker
٨	2

Scale

1/4" = 1'-0"

NOC:30:8 44

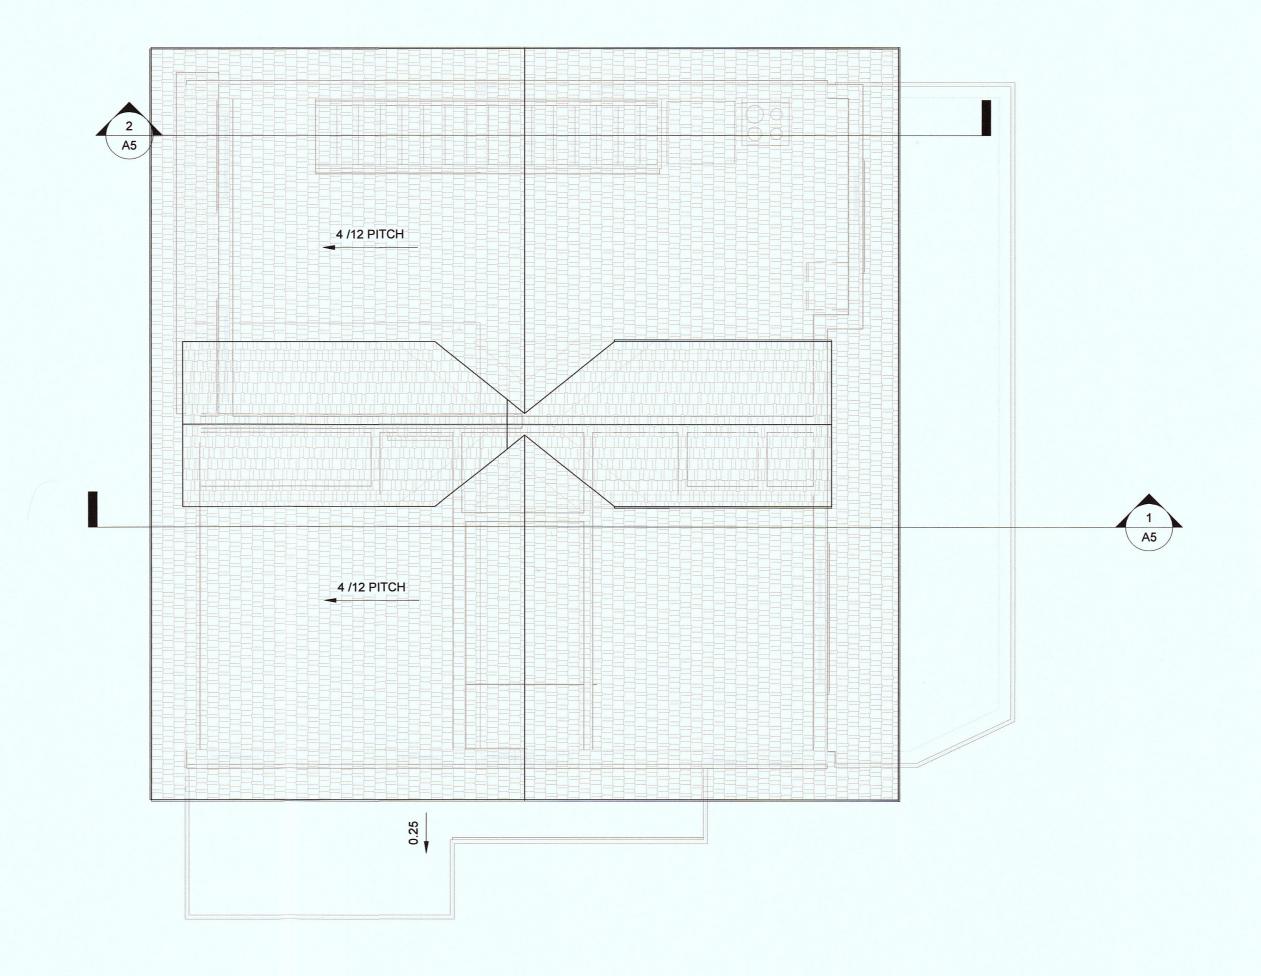

1 Roof Plan 1/4" = 1'-0"



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HOMES

Cutting Edge Homes

270 E Douglas Avenue
El Cajon,, CA 92020
310 867 3993

No.	Description	Date
Α	PRELIMINARY DESIGN	2015.09
В	REVISED DRAWINGS	2015.10
С	PLANNING SUBMITTAL	2015.12
D	PLANNING CHANGES	2016.05
Е	PLANNING CHANGES	2016.12

LIN & JIANG RESIDENCE 2 STORY HOME Roof Plan

A	3
Checked by	Checker
Drawn by	Author
Date	2015-09-16
Project number	15-1715



1 North 1/4" = 1'-0"

PLANNING REQUIREMENTS:

MAX HEIGHT: MAX PARCEL COVERAGE: 28'-0" 16'-0" + 35%



Materials Legend



STONE - LIMESTONE RUSTIC (OR SIMILAR)



30 YEAR COMP SHINGLE BY **OWENS CORNING**

TYPE: DRIFTWOOD




FIBER CEMENT HORIZONTAL WALL SIDING

COLOR: EUCALYPTUS TREE



FIBER CEMENT BOARD & BATTEN COLOR: EUCALYPTUS TREE

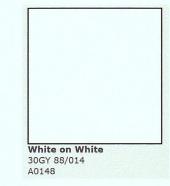

WINDOW TRIM: 5/4 FASCIA BOARD: 7.5" MIN. COLOR: WHITE ON WHITE



SHINGLES AT GABLES COLOR: WHITE SHAKE



THESE CONSTRUCTION DOCUMENTS CREATED BY CUTTING THESE CONSTRUCTION DOCUMENTS CREATED BY CUTTING EDGE HOMES ARE AN INSTRUMENT OF SERVICE PROVIDED TO THE OWNER BY THE DESIGNER. THESE DOCUMENTS ARE OWNED BY THE DESIGNER AND COPIES FOR APPROPRIATE PERMITS AND CONSTRUCTION SHALL BE PROVIDED TO THE OWNER. THESE DOCUMENTS SHALL NOT BE USED FOR ANY PROJECT OTHER THAN THE SPECIFIC PROJECT CONTRACT FOR. NO EXCEPTIONS.

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В	REVISED DRAWINGS	2015.10
С	PLANNING SUBMITTAL	2015.12
D	PLANNING CHANGES	2016.05
Е	PLANNING CHANGES	2016.12

LIN & JIANG RESIDENCE 2 STORY HOME

Elevations

Project number	15-1715
Date	2015-09-16
Drawn by	E.D.S
Checked by	C.F
A	4

Scale

2 South 1/4" = 1'-0"


1/4" = 1'-0"




Materials Legend



STONE - LIMESTONE RUSTIC (OR SIMILAR)

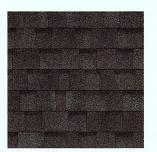

30 YEAR COMP SHINGLE BY OWENS CORNING

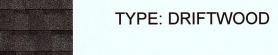



FIBER CEMENT HORIZONTAL WALL SIDING





FIBER CEMENT BOARD & BATTEN COLOR: EUCALYPTUS TREE



WINDOW TRIM: 5/4
FASCIA BOARD: 7.5" MIN. COLOR: WHITE ON WHITE



SHINGLES AT GABLES COLOR: WHITE SHAKE



MARINE S BEACH, **∞**ŏ

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Cutting Edge I

No.	Description	Date
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В	REVISED DRAWINGS	2015.10.0
С	PLANNING SUBMITTAL	2015.12.3
D	PLANNING CHANGES	2016.05.2
E	PLANNING CHANGES	2016.12.2
N. EVE		

LIN & JIANG RESIDENCE 2 STORY HOME Elevations


15-1715 2015-09-16 Author Drawn by Checker Checked by


A4.1

1/4" = 1'-0"

2 West 1/4" = 1'-0"

1 East 1/4" = 1'-0"

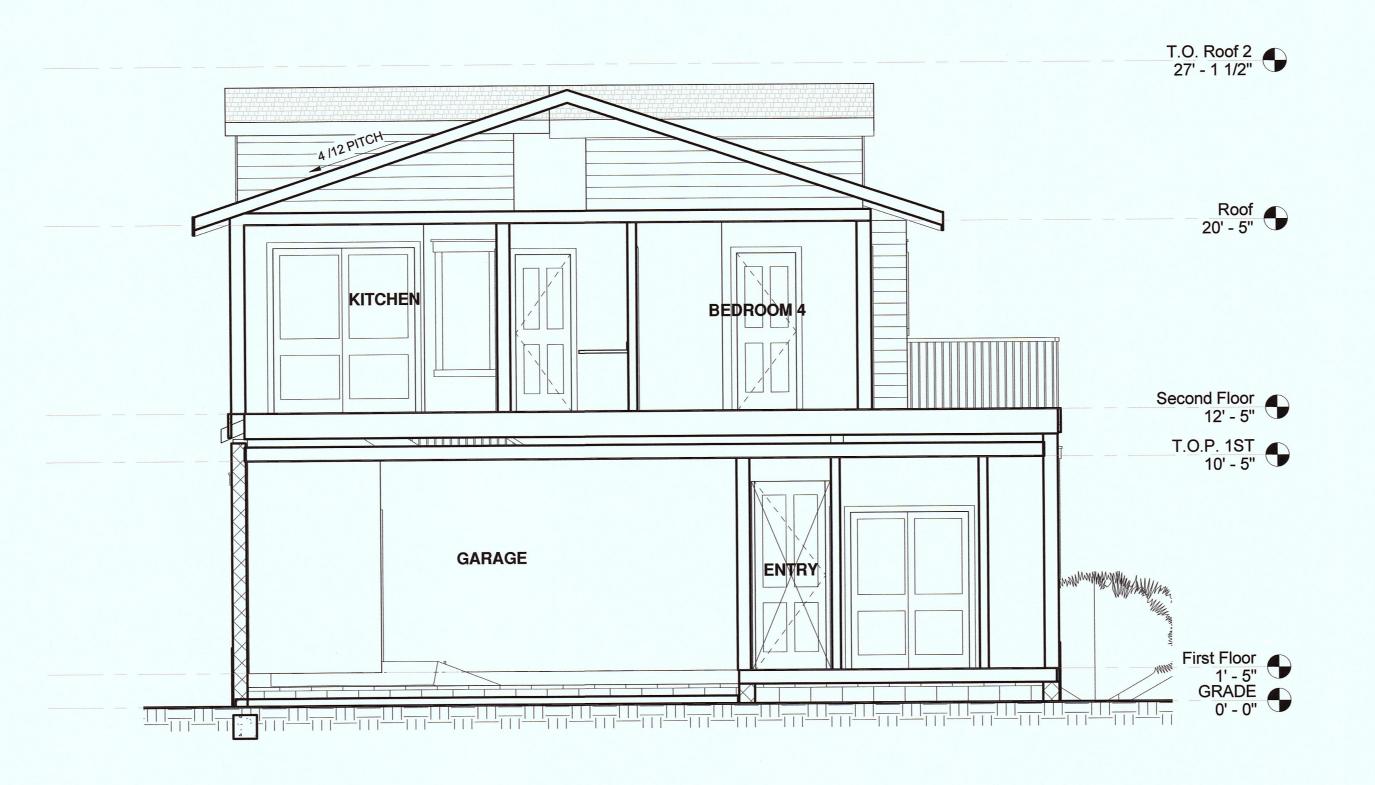

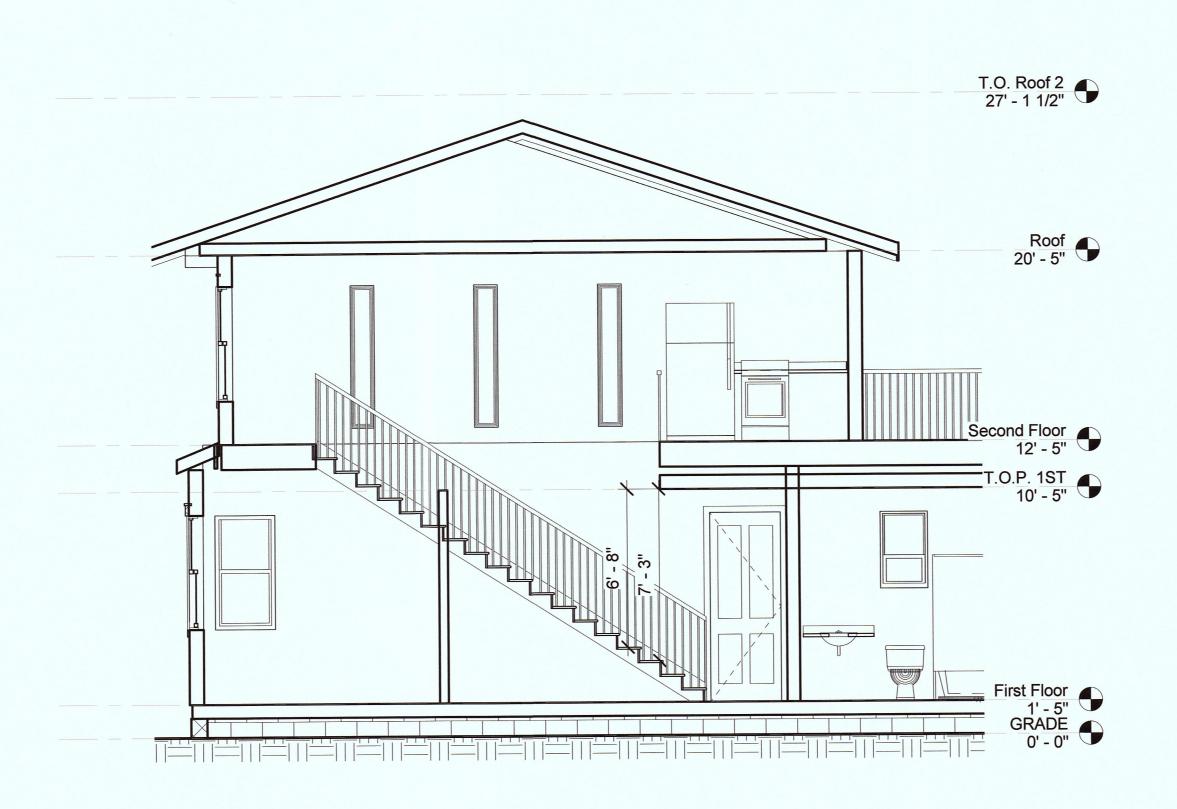

2 Section 2 1/4" = 1'-0"

1 Section 1 1/4" = 1'-0"

LIN & JIANG RESIDENCE O MARINE BLVD. AOSS BEACH, CA 94038

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HOMES

Cutting Edge Homes

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El Cajon,, CA 92020
310 867 3993

No.	Description	Date
Α	PRELIMINARY DESIGN	2015.09.16
В	REVISED DRAWINGS	2015.10.03
С	PLANNING SUBMITTAL	2015.12.31
D	PLANNING CHANGES	2016.05.23
E	PLANNING CHANGES	2016.12.27
F- 5.6		

LIN & JIANG RESIDENCE
2 STORY HOME
Building Section

Project number	15-1715
Date	2015-09-16
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LIN & JIANG RESIDENCE OMARINE BLVD.

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С	PLANNING SUBMITTAL	2015.12.3
D	PLANNING CHANGES	2016.05.23
E	PLANNING CHANGES	2016.12.27

LIN & JIANG RESIDENCE 2 STORY HOME

3D View

Project number 15-1715

Date 2015-09-16

Drawn by Author

Checked by Checker

16

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4/23/2016

WINDOW			A process of the control of the cont		SQ. FT.	SQ. FT.	SQ. FT.	SQ. FT.	SQ. FT.
NUMBER	CALL OUT		ROUGH OPENING	DESCRIPTION	LIGHT	VENT	R.O.	LT. AREA	VT. AREA
WOWIDER	CALLOGI	Carrelland	A S						
W- 5	40 x 38 H		40 1/2 x 38 1/2	H.S.	8.01	4.33	10.83	100.13	108.25
W- 8	96 x 39 H		96 1/2 x 40	H.S. XOX	21.26	11.19	26.81	265.75	279.7
W- 9E	96 x 58 H		96 1/2 x 59	H.S. XOX	31.85	16.18	39.54	398.13	404.50
W-10E	78 x 58 H		78 1/2 x 59	H.S. XOX	26.01	15,37	32.16	325.13	384.25
W-12	46 x 10 H		46 1/2 x 10 1/4	H.S.	1.57	1.25	3.23	19.63	31.25
W-16	24 x 27 H		24 1/2 x 27 1/4	H.S. OBS	2.83	1.61	4.63	35.38	40.25
W-17	46 x 48 H OBS		46 1/2 x 48 1/4	H.S. (SAFETY) OBS	12.12	6.46	15.54	151.50	161.50
W-19	46 x 48 H		46 1/2 x 48 1/4	H.S. (SAFETY)	12.12	6.46	15.54	151.50	161.50
W-20	24 x 80 V		24 1/2 x 80 1/2	PARTIAL FIXED 1/4 VENT	10.17	3.98	13.70	127.13	99.50
W-21E	36 x 80 V	(mulled)	36 1/2 x 80 1/2	PARTIAL FIXED 1/4 VENT	16.10	6.19	20.40	201.25	154.75
W-22E	46 x 80 V	(mulled)	46 1/2 x 80 1/2	PARTIAL FIXED 1/4 VENT	21.04	8.04	25.99	263.00	201.00
W-24	46 x 52 VS		46 1/2 x 52 1/2	PARTL FIXED 1/4 VENT(SAFETY)	12.91	3.42	16.95	161.375	85.5
W-25	36 x 52 V		36 1/2 x 52 1/2	PARTIAL FIXED 1/4 VENT	9.9	2.63	13.31	123.75	65.75
W-28E	30 x 80 V	(mulled)	30 1/2 x 80 1/2	V.S. 1/2 VENT	13.14	5.11	17.05	164.25	127.75
W-32E	46 x 39 H		46 1/2 x 40	H.S.	9.82	5.27	12.92	122.75	131.79
W-33	46 x 39 H OBS		46 1/2 x 40	H.S. (SAFETY) OBS	9.82	5.27	12.92	122.75	131.75
W-34	46 x 39 H		46 1/2 x 40	H.S. (SAFETY)	9.82	5.27	12.92	122.75	131.75
W-35E	30 x 58 V		30 1/2 x 59	V.S. 1/2 VENT	9.48	5.08	12.5	118.5	127
W-36	46 x 39 P OBS		46 1/2 x 40	P.W. (SAFETY)	9.82	5.27	12.92	122.75	131.75
W-37			24 1/2 x 58 7/8	V.S.	7.31	3.98	10.01	91.375	99.5
W-38			14 1/2 x 58 7/8	V.S.	3.7	2.13	5.93	46.25	53.25
W-45	24 x 39 V		24 1/2 x 40	V.S.	4.65	2.41	6.8	58.125	60.25
W-47			21 1/2 x 59	V.S.	6.23	3.42	8.81	77.875	85.5
W-60			54 1/2 x 27 1/4	H.S.	7.65	4.08	10.31	95.625	102
W-61			30 1/2 x 27 1/4	H.S.	3.81	2.07	5.77	47.625	51.75
W-63E	36 x 58 V		36 1/2 x 59	V.S. 1/2 VENT	11.65	6.19	14.95	145.625	154.75
W-64E	46 x 58 V		46 1/2 x 59	V.S. 1/2 VENT	15.27	8.04	19.05	190.875	203
W-72	30 x 39 V		30 1/2 x 40	V.S. 1/2 VENT	6.03	3.08	8.47	75.38	77.00
W-73	30 x 36 V		30 1/2 x 36 1/4	V.S. 1/2 VENT	5.37	2.73	7.60	67.13	68.25
W-75	24 x 54 VS	And the second second	24 1/2 x 54 1/2	V.S. VENT (SAFETY)	6.60	3.32	9.27	82.50	83.00
W-76	14 x 39 VO		14 1/2 x 40	V.S. VENT OBS	2.35	1.29	4.02	29.38	32.25
W-79	24 x 54 V		24 1/2 x 54 1/2	V.S. VENT OBS (SAFETY)	6.60	3.32	9.27	82.50	83.00
W-91	30 x 27 V		30 1/2 x 27 1/4	V.S. 1/2 VENT	3.73	2.06	5.77	46.625	51.5

CuttingEdgeHomes.Net

Revised:

4/23/2016

WINDOW				SQ. FT.	SQ. FT.	SQ. FT.	SQ. FT.	SQ. FT.
NUMBER	CALL OUT	ROUGH OPENING	DESCRIPTION	LIGHT	VENT	R.O.	LT. AREA	VT. AREA
W-13	46 x 10 P	46 1/2 x 10 1/4	FIXED	2.23	0	3.23	27.875	
W-14*	18 x 18 BLOCK	17 5/8 x 17 5/8	18" SQUARE ACRILIC BLOCK	1.77	0	2.16	22.125	
W-15*	48 x 48 BLOCK	48 1/4 X 48 1/4	48" SQUARE ACRILIC BLOCK	14.69	0	16.17	183.625	
W-23	36 x 10 P	36 1/2 x 10 1/4	FIXED	1.72	0	2.53	21.5	
W-26	12 x 72 P	12 1/2 x 72 1/4	FIXED (SAFETY)	4.64	0	6	58	
W-29	72 x 12 P	72 x 12 1/4	FIXED	4.5	0	6.13	56.25	
W-30	75 x 12 P	75 x 12 1/4	FIXED	4.71	0	6.38	58.875	
W-31	PRISM	62 1/2 x15 x 26 1/2 x 15	FIXED PENTAGON	4.7) 0	4.76	58.75	
W-46	30x12 P	30 1/2 x 12 1/2	FIXED	1.89	0	2.65	23.625	
W-48	36 x 25 P	36 1/2 x 25	FIXED	5.17	0	6.33	64.625	
W-49	30 x 25 P	30 1/2 x 25	FIXED	4.24	0	5.3	53	en e
W-50	46 x 25 P	46 1/2 x 25	FIXED	6.7	0	8.07	83.75	
W-57		28 x 4 1/2 x 23 1/2	FW TRAP	1.9	0	2.7	23.75	
W-58		28 x 23 1/2 x 4 1/2	FW TRAP	1.9	0	6.2	23.75	Assert contract of the second
W-59		28 x 27 1/4 x 36 1/2 x 27 1/4	FIXED PENTAGON	5.1	0	2.7	63.75	
W-89	24 x 14 P	24 1/2 x 14 1/4	FIXED	1.71	0	2.42	21.375	
W-90	36 x 14 P	36 1/2 x 14 1/4	FIXED	2.66	0	4.6	33.25	
W-92	73 x 14 P	73 1/4 x 14 1/4	FIXED	5.56	0	7.25	69.5	

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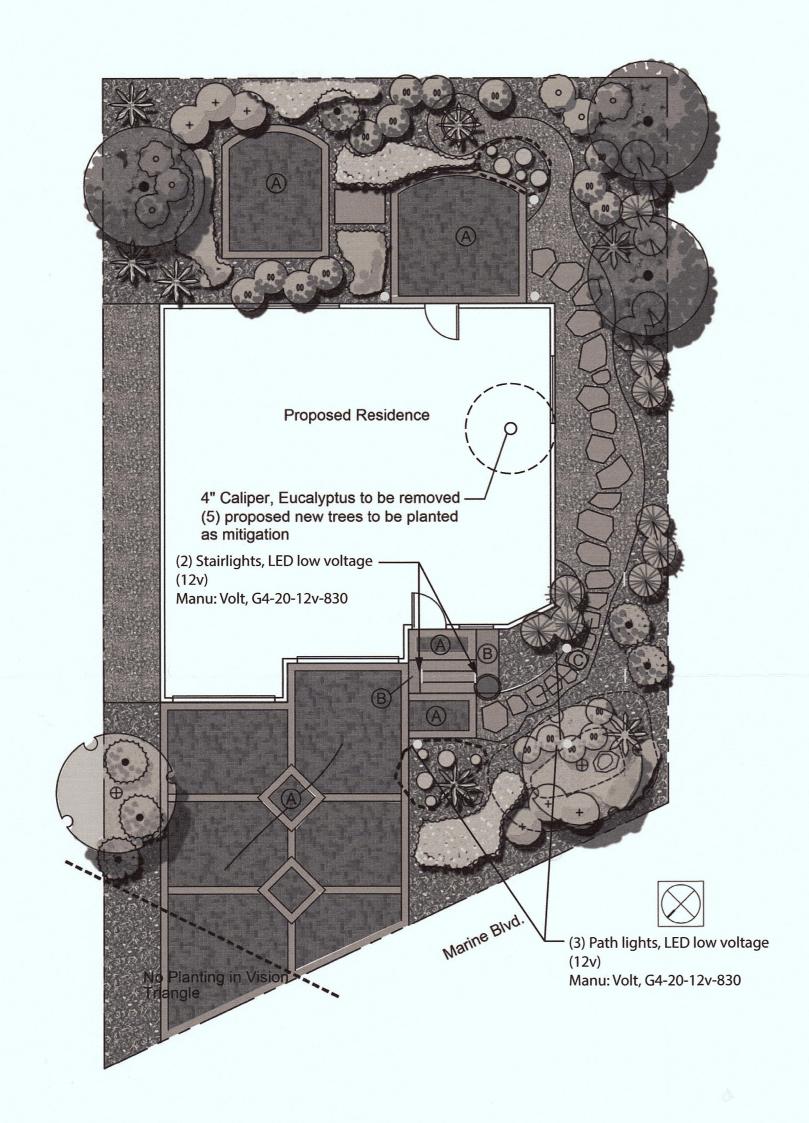
No.	Description	Date
Α	PRELIMINARY DESIGN	2015.09.16
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С	PLANNING SUBMITTAL	2015.12.3
D	PLANNING CHANGES	2016.05.23
E	PLANNING CHANGES	2016.12.27


LIN & JIANG RESIDENCE 2 STORY HOME Window Schedule

Date	2015-09-16
Drawn by	Author
Checked by	Checker


Scale

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General Notes

1 Total Landscape Square Footage - 1,776 s.f. Hardscape = 914 s.f.

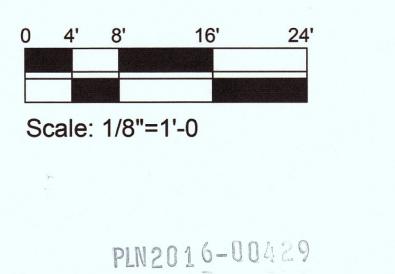Echeveria agavoides

Crassula spp.

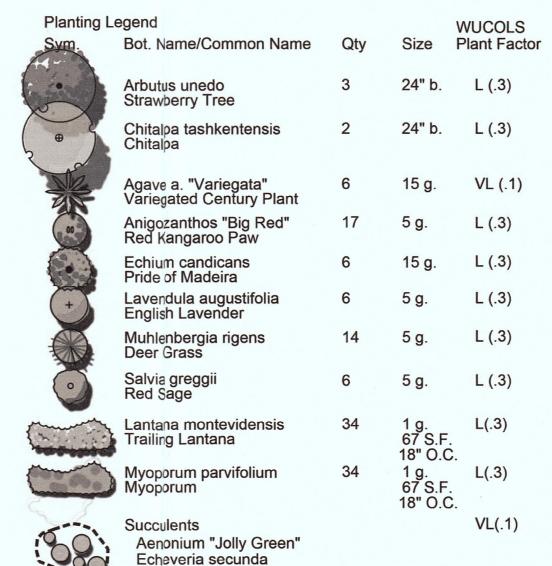3" Layer Bark Mulch


* Less than 2,500 s.f., Exempt from Water Efficient Landscape Worksheet

3" Layer Decomposed Granite

- All landscaped areas shall recieve compost at a rate of four(4) cubic yards per 1,000 s.f. to a minimum depth of 6". *Unless otherwise specified from agronomic soils report.
- 3 There is no purposed turf for this project.
- Irrigation controller shall use ET data or soil moisture data as a base program. A rain sensor shall also be installed. Controller shall not lose programming information in case of power outage.
- 5 All irrigation systems shall be drip (low flow) irrigation.
- 6 All plant material is a WUCOLS plant factor of .3 or less.

Construction Legend

- A Interlocking pavers
- B Stone Veneer Walls
- C Flagstone Step Stones

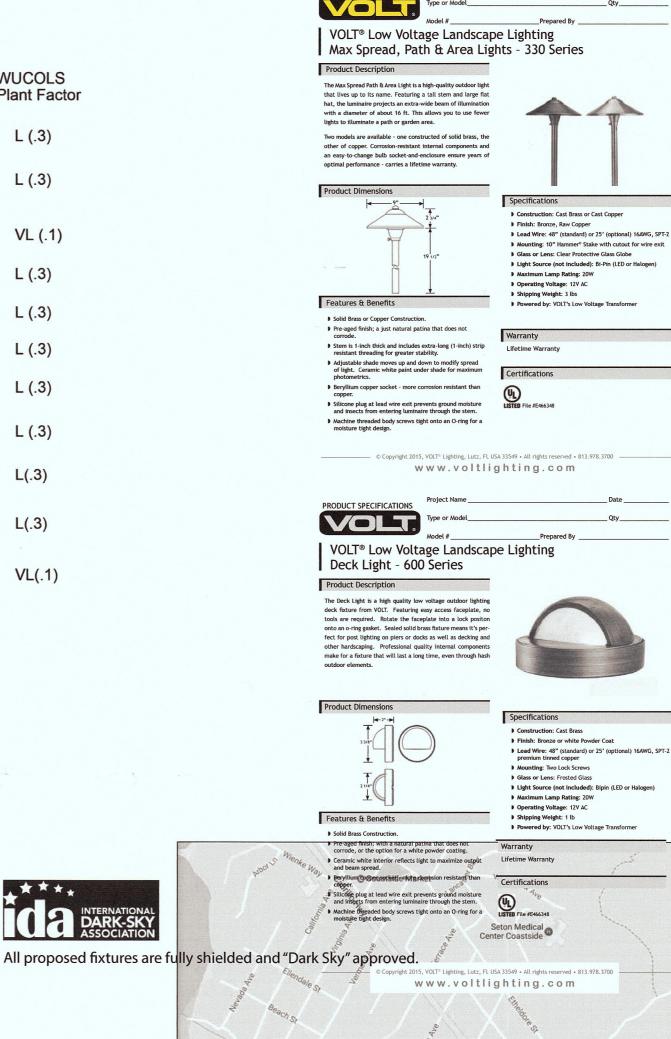

PRODUCT SPECIFICATIONS



Cypress Meadows 🖸



Google